


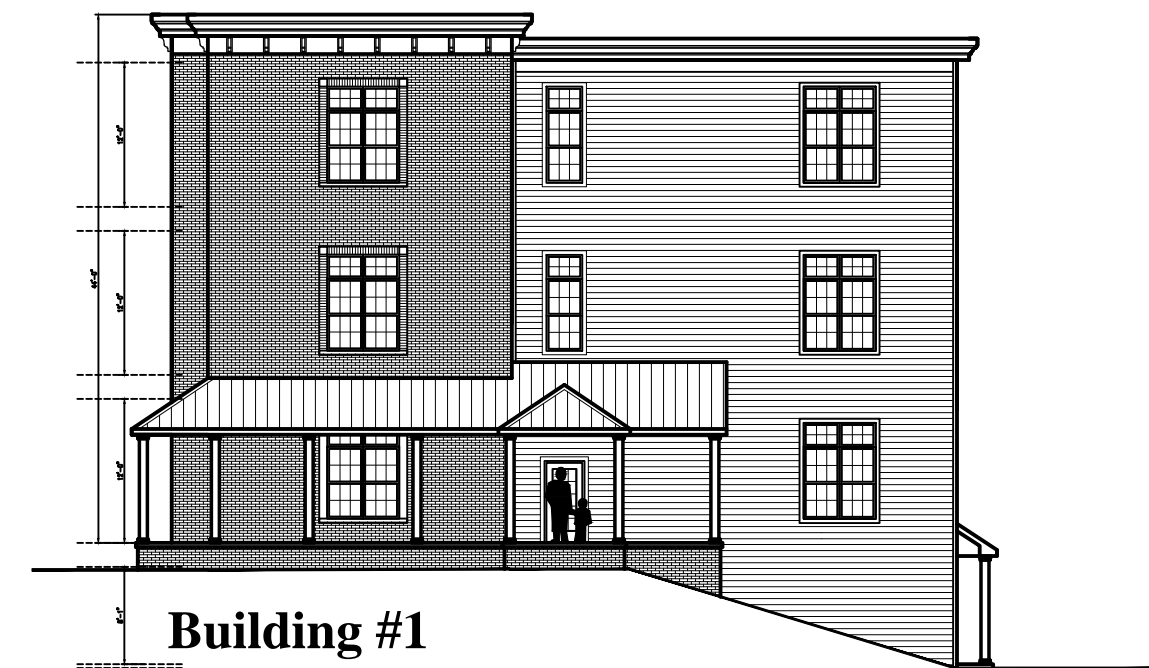


Building #1

1 Front Elevation (Wolcott Entrance)
A1 Scale: 1/16" = 1'-0"

Building #2



Building #1

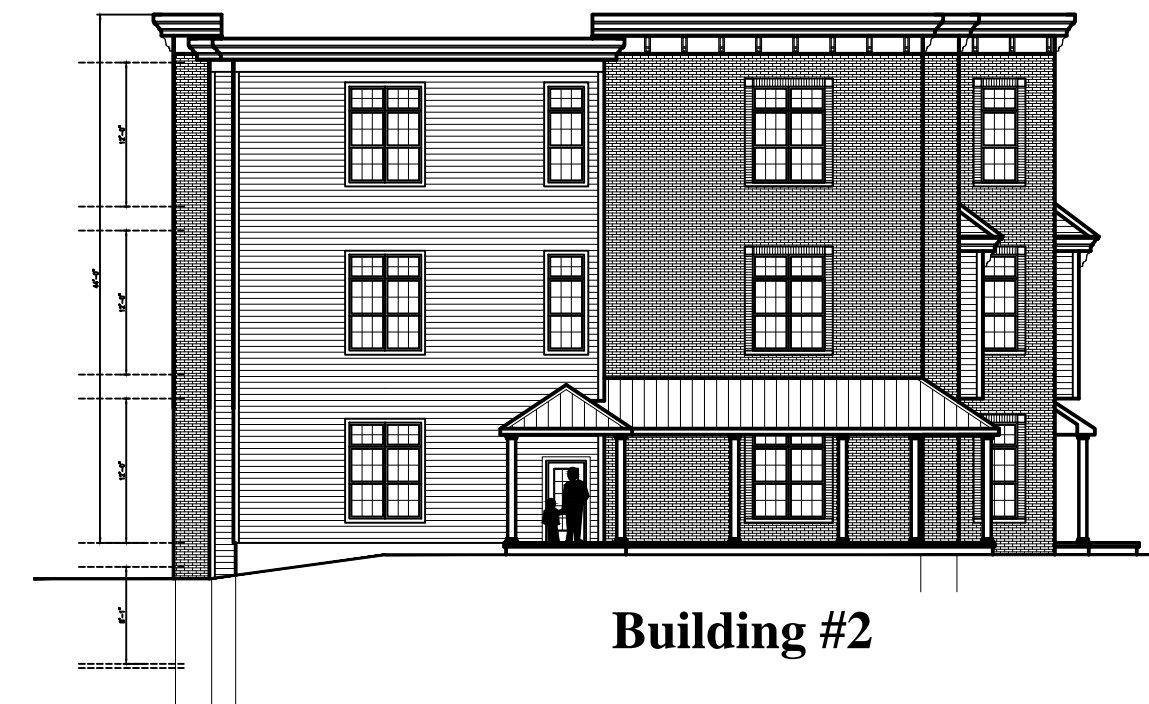

Building #2




3 Building #2 - North Elevation
A1 Scale: 1/16" = 1'-0"

2 Driveway Elevations
A1 Scale: 1/16" = 1'-0"



Front

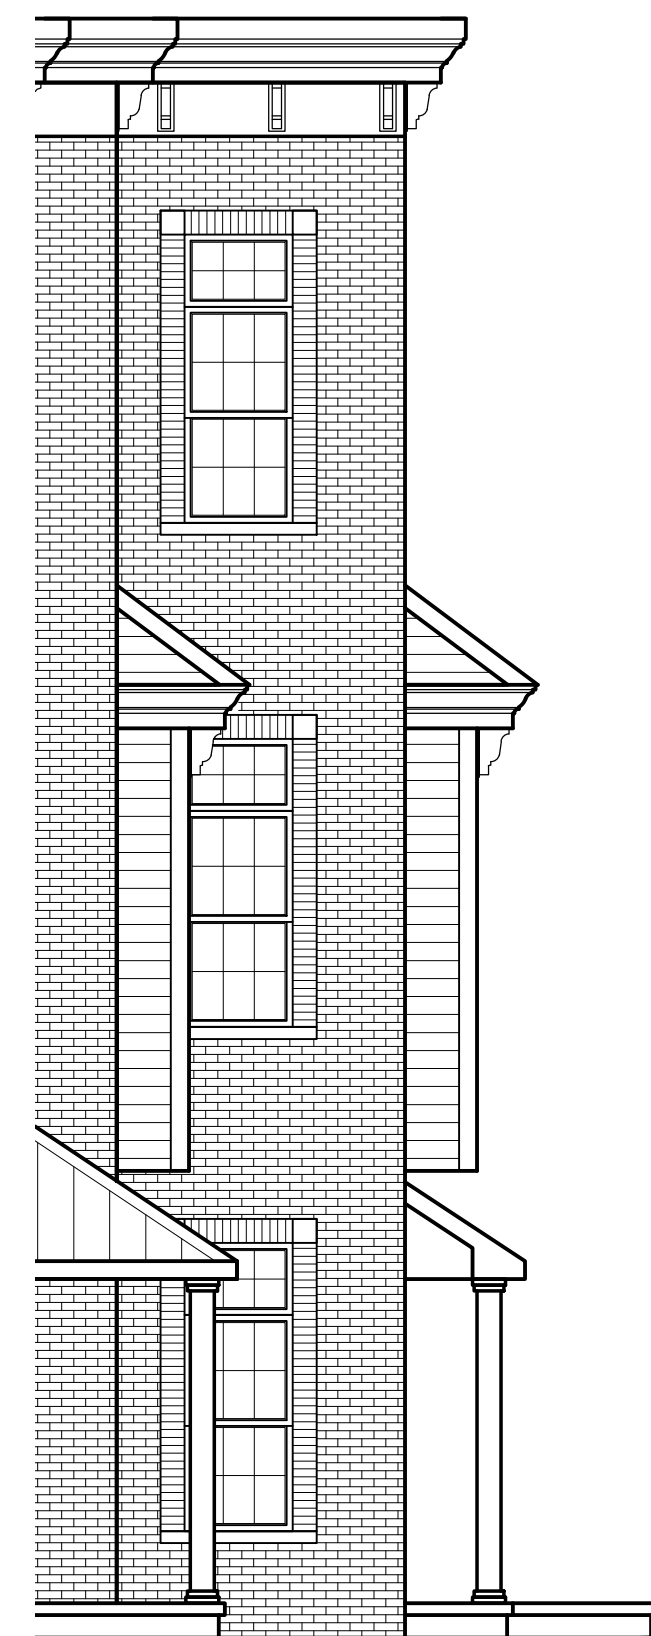


Side

4 Projection Bay Elevation
A1 Scale: 1/4" = 1'-0"


Exterior Finishes;

- Brick: Watsontown Delaware Type 2 Modular
- Siding: James Hardie Fiber Cement, Slate Gray
- Siding Trim Boards: Light Gray
- Columns: Fiberglass, Painted Light Gray
- Cornice, Trims: Painted Light Gray
- Cornice Brackets: Painted Dark Gray
- Aluminum Roofing: Dark Gray
- Doors: Painted Burgundy
- Windows: Aluminum, Baked Enamel, Dark Bronze
- Prefabricated Aluminum Railings, Dark Bronze

West End Lofts, Beacon, NY - Unit Breakdown						
Building #	1 Br Apartment	1 Br Apartment	1 Br Apartment	2 Br Apartment	2 Br Apartment	Totals
	743 s.f.	741 s.f.	768 s.f.	969 s.f.	1080 s.f.	
1	0	14	0	14	0	28
2	3	28	0	14	0	45
3	0	0	11	0	14	25
TOTALS						
# of Units	3	42	11	28	14	98
Total Area	2229	31122	8448	27132	15120	84,051

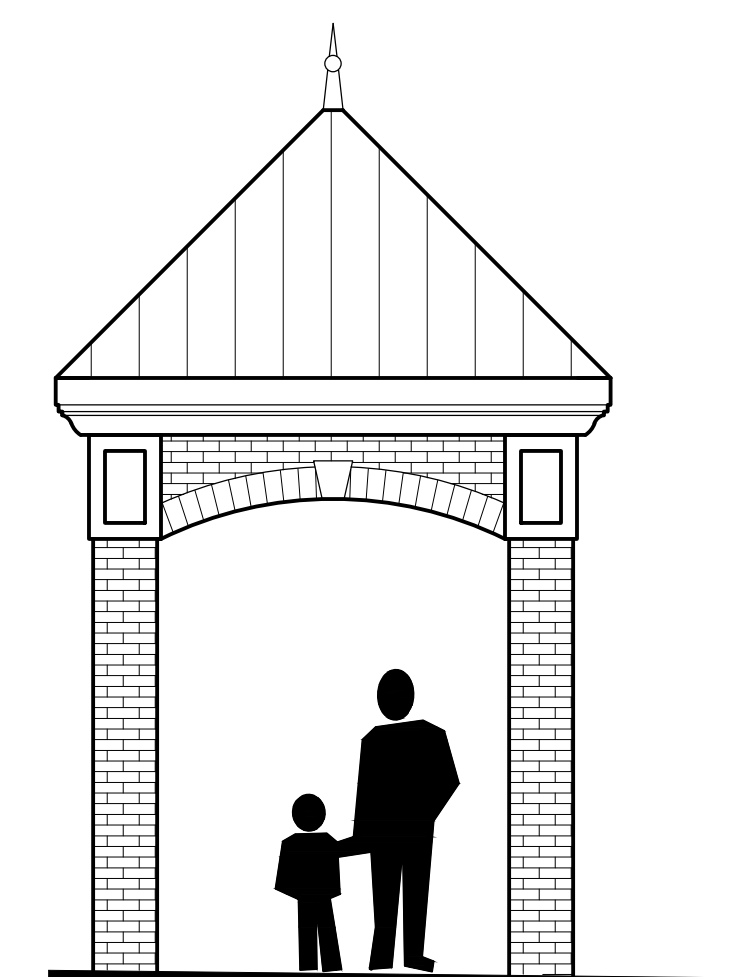

5 Portico Elevation
A1 Scale: 1/4" = 1'-0"

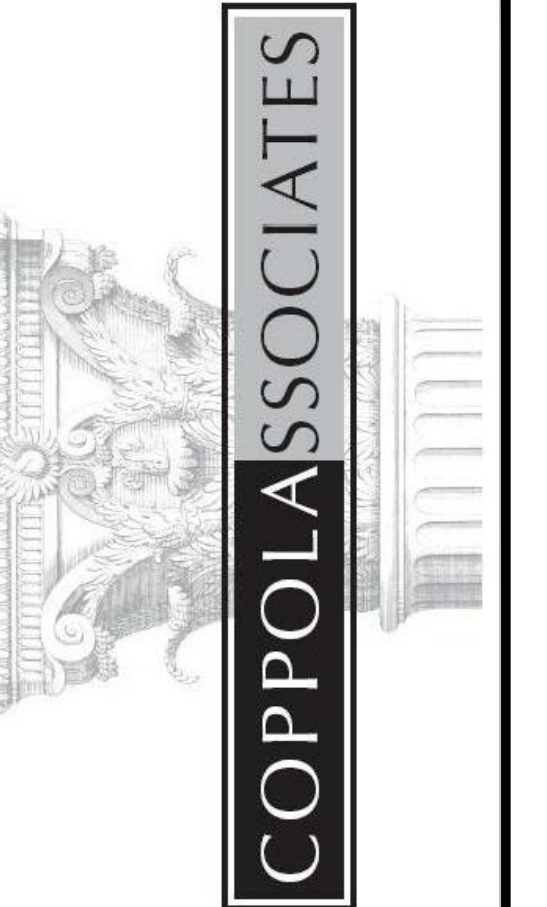

Design, Architecture & Planning
6 Old North Plank Road
Suite 101
Newburgh, NY 12550
TEL: 845-561-3559
FAX: 845-561-2051
ajcoppola@coppola-associates.com

ajc

LICENSE NUMBER: 018849

PROPOSED MULTIFAMILY
DWELLING FOR

West End Lofts

City of Beacon, NY

**Buildings #1 and #2
Elevations**

REVISIONS

DATE

5/25/17

PROJECT NUMBER


16-01

SHEET NUMBER

A1

REVISIONS	
DATE	
5/25/17	
PROJECT NUMBER	
16-01	
SHEET NUMBER	

- Exterior Finishes;
- Brick: Watson town Delaware Type 2 Modular
 - Siding: James Hardie Fiber Cement, Slate Gray
 - Siding Trim Boards: Light Gray
 - Columns: Fiberglass, Painted Light Gray
 - Cornice, Trims: Painted Light Gray
 - Cornice Brackets: Painted Dark Gray
 - Aluminum Roofing: Dark Gray
 - Doors: Painted Burgundy
 - Windows: Aluminum, Baked Enamel, Dark Bronze
 - Prefabricated Aluminum Railings, Dark Bronze

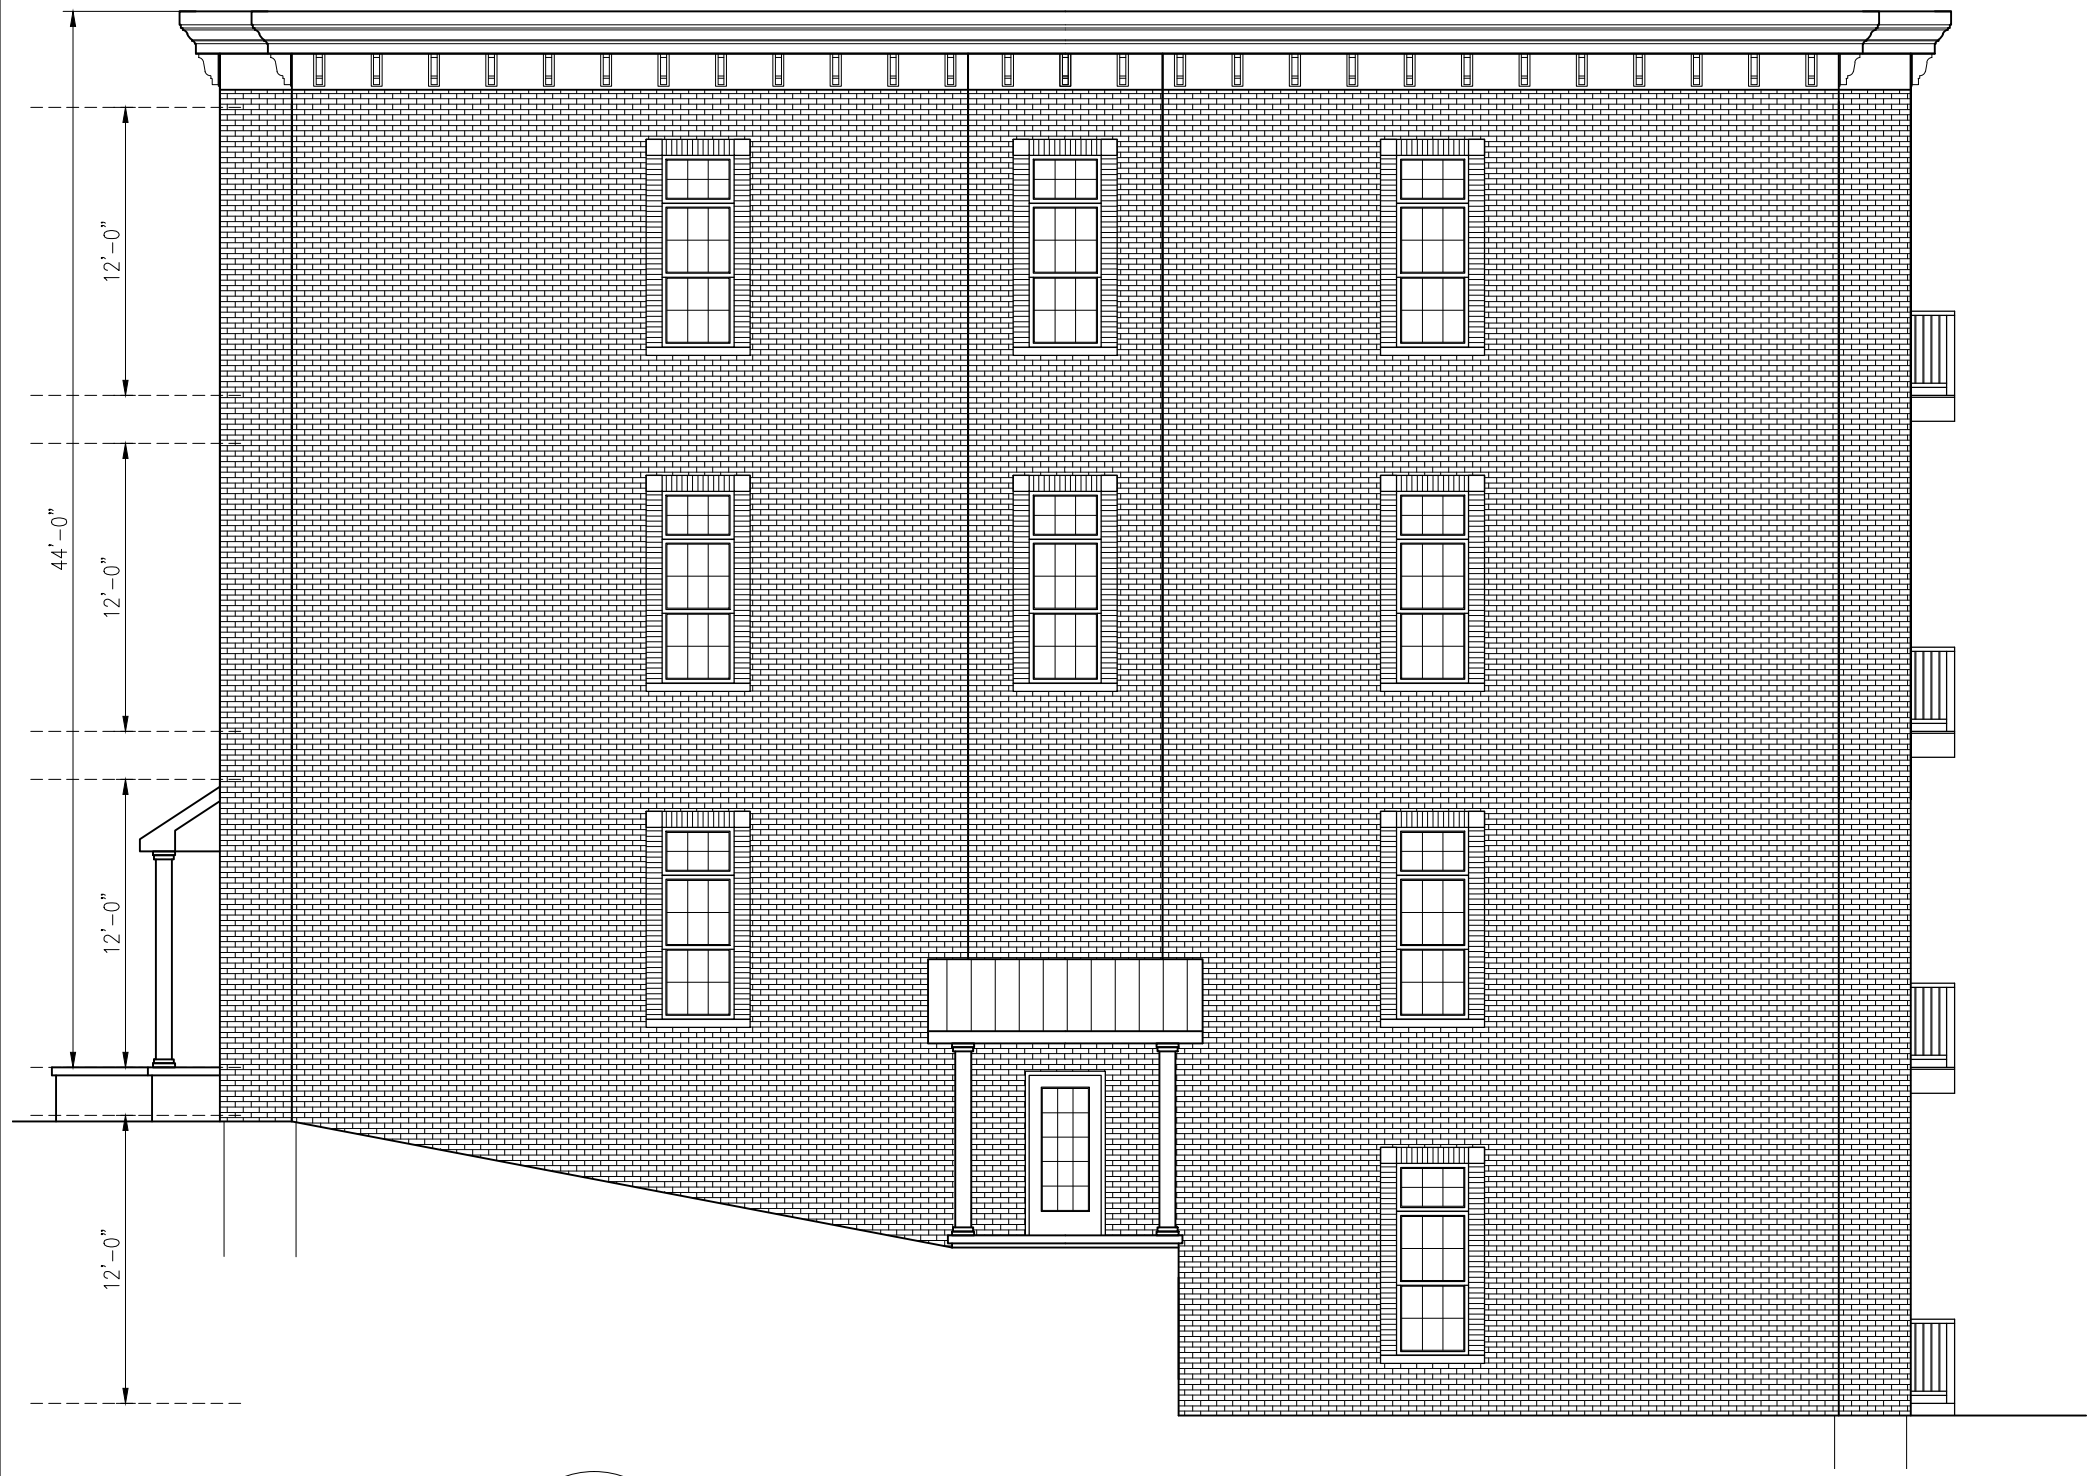

1 Typical Side Elevation
A2 Scale: 1/8" = 1'-0"



2 West (Rear) Elevation
A2 Scale: 1/8" = 1'-0"



3 East (Front) Elevation
A2 Scale: 1/8" = 1'-0"