GENERAL NOTES:

THE PROPOSAL CALLS FOR CONSTRUCTION OF A NEW STRUCTURE ON THE EASTERN LOT, AS MODIFIED BY A CONCURRENT LOT LINE REALIGNMENT APPLICATION. THE STRUCTURE IS GENERALLY BROKEN DOWN AS FOLLOWS:

A. 2,406 SQFT OF SINGLE FAMILY RESIDENTIAL. B. 626 SQFT GARAGE.

. 646 ACCESSORY APARTMENT

. 594 UNFINISHED STORAGE ABOVE GARAGE.

211 SQFT COMMON FOYER. SINGLE FAMILY RESIDENTIAL USE IS PERMITTED BY RIGHT IN THE R1-7.5 ZONING DISTRICT. ACCESSORY APARTMENTS ARE SPECIALLY PERMITTED USES IN THE HISTORIC OVERLAY AND LANDMARK DISTRICT AND REQUIRES SITE PLAN APPROVAL FROM THE PLANNING BOARD AND SPECIAL USE PERMIT ISSUANCE FROM THE CITY COUNCIL.

2. EXISTING PLANIMETRIC INFORMATION FOR THE OVERALL SITE WAS TAKEN FROM A MAP PREPARED BY DECKER SURVEYING, P.C. IN MARCH OF 2019.

5. THE SITE DOES NOT CONTAIN ANY WETLANDS OR FLOODPLAINS PER AVAILABLE GIS MAPPING. 4. THE PROJECT IS SERVICED BY PUBLIC WATER AND SEWER FROM THE CITY OF BEACON WATER AND SEWER DISTRICTS,

- GENERAL CONSTRUCTION NOTES:

 1. THE CONTRACTOR SHALL PERFORM A UTILITIES CALL—OUT PRIOR TO CONSTRUCTION TO VERIFY ALL UNDERGROUND UTILITY LOCATIONS BY CONTACTING UFPO @ 1-800-962-7962.
- 2. WATER, SEWER AND STORM SHALL BE CONSTRUCTED IN ACCORDANCE WITH THE PLANS. ALL OTHER UTILITIES (TELEPHONE, ELECTRIC, GAS, CABLE, ETC.) SHALL BE INCORPORATED FOLLOWING SITE PLAN APPROVAL. ALL SUCH
- ÙTILITY DESIGNS SHALL BE DEVELOPED IN COOPERATION WITH THE RESPECTIVE UTILITY COMPANIES. 3. THE CONTRACTOR SHALL FIELD VERIFY THE SIZE, LOCATION, DEPTH AND CONDITION OF ALL UTILITIES AND REPORT ANY DISCREPANCIES TO THE ENGINEER. THE CONTRACTOR SHALL NOT ASSUME THAT ALL LOCATIONS AS SHOWN ON
- 4. THE CONTRACTOR SHALL CONSTRUCT ALL IMPROVEMENTS AS SHOWN ON PLANS. ANY FIELD CONDITIONS THAT MAY RESULT IN A VARIATION FROM THE PLAN SET SHALL BE BROUGHT TO THE ENGINEERS ATTENTION IN WRITING. VARIATIONS FROM THE PLAN WITHOUT APPROVAL FROM THE ENGINEER WILL BE CONSIDERED DEFICIENT.
- THE CONTRACTOR SHALL BE RESPONSIBLE FOR ON-SITE OR OFF-SITE DAMAGES TO VEGETATION OR PROPERTY CAUSED BY HIS OPERATIONS. SUCH DAMAGES SHALL BE REPAIRED OR REPLACED AT THE CONTRACTORS COST TO THE SATISFACTION OF THE ENGINEER, PROPERTY OWNER OR AGENCY HAVING JURISDICTION.
- THE CONTRACTOR SHALL SECURE ALL NECESSARY PERMITS PRIOR TO CONSTRUCTION. 7. THE CONTRACTOR SHALL SECURE THE WORK LIMITS OF THE SITE BY INSTALLATION OF CONSTRUCTION FENCING AND OTHER MEASURES, AS NECESSARY TO PREVENT NON-AUTHORIZED ENTRY.
- 8. THE CONTRACTOR SHALL KEEP THE SITE IN A CLEAN AND ORDERLY MANNER. THE CONTRACTOR SHALL NOT INTERRUPT EXISTING ACCESS OR OPERATIONS FOR THE REMAINDER OF THE SITE. 10. THERE IS NO DISTURBANCE WITHIN THE RIGHT-OF-WAY OF NYS ROUTE 9D, THEREFORE, THERE ARE NO PERMITS
- REQUIRED BY THE NEW YORK STATE DEPARTMENT OF TRANSPORTATION. 11. THE INSTALLED EXPANSION JOINTS IN THE CONCRETE SIDEWALK RESTORATION AREAS SHALL MATCH THE EXISTING EXPANSION JOINT SPACING ON THE EXISTING SIDEWALK ON RALPH STREET.

SPECIAL ACCESSORY APARTMENT NOTES:

. THE OWNER OF THE SINGLE-FAMILY LOT UPON WHICH AN ACCESSORY APARTMENT IS LOCATED SHALL OCCUPY AT LEAST ONE THE DWELLING UNITS.

2. THE MINIMUM FLOOR AREA FOR AN ACCESSORY APARTMENT SHALL BE 400 SQFT. THE MAXIMUM FLOOR AREA SHALL BE 650 SQFT, BUT IN NO CASE SHALL THE FLOOR AREA OF THE APARTMENT EXCEED 30% OF THE TOTAL FLOOR AREA OF THE DWELLING BUILDING IN WHICH IT IS LOCATED. THE PROPOSED ACCESSORY APARTMENT IS 646 SQFT, OR APPROXIMATELY 16.7% OF THE TOTAL FLOOR AREA OF THE DWELLING BUILDING (CALCULATION DOES NOT INCLUDE GARAGE FLOOR AREA).

3. FOR ACCESSORY APARTMENTS LOCATED IN A DETACHED SINGLE-FAMILY DWELLINGS, THE ENTRY TO SUCH UNIT AND ITS DESIGN SHALL BE SUCH THAT, TO THE DEGREE REASONABLY FEASIBLE, THE EXTERIOR APPEARANCE OF THE BUILDING WILL RETAIN THAT OF A SINGLE-FAMILY RESIDENCE. THE PLAN CALLS FOR A SINGLE ENTRY LEADING TO A COMMON FOYER, THEREBY PROVIDING AN EXTERIOR APPEARANCE OF A SINGLE-FAMILY RESIDENCE.

4. THE ACCESSORY APARTMENT SHAL BE INSPECTED BY THE BUILDING DEPARTMENT EVERY TWO YEARS IN ORDER TO DETERMINE WHETHER THE APARTMENT REMAINS IN COMPLIANCE. UPON A SATISFACTORY INSPECTION REPORT, THE ACCESSORY APARTMENT OWNER SHALL BE REISSUED A CERTIFICATE OF OCCUPANCY. IN THE EVENT THAT THE INSPECTION INDICATES THAT THE ACCESSORY APARTMENT IS NOT IN COMPLIANCE, THE CERTIFICATE OF OCCUPANCY SHALL BE REVOKED UNTIL THE VIOLATIONS ARE CURED.

BUILDING PERMIT NOTE:

1. THE APPLICANT HEREBY AGREES THAT HE/SHE WILL NOT REQUEST A BUILDING PERMIT FOR LOT 2 UNTIL SUCH TIME THAT THE CITY OF BEACON HAS MADE CERTAIN IMPROVEMENTS TO THE WEST MAIN STREET SEWAGE PUMP STATION.

DRAWING INDEX:

SHEET 1: COVER SHEET: CV-1

SHEET 2: EXISTING CONDITIONS & REMOVALS PLAN: XC-1

SHEET 3: SUBDIVISION & SITE PLAN: SP-1

SHEET 4: EROSION & SEDIMENT CONTROL PLAN & GRADING AND UTILITY PLAN: GU-1

CHECKED BY: DGK

SHEET 5: CONSTRUCTION DETAILS: CD-1

SHEET 6: CONSTRUCTION DETAILS: CD-2

DRAWN BY: CMB

REVISIONS: NO. DATE DESCRIPTION BY NO. DATE DESCRIPTION BY 1 11/26/19 PER PLANNING BOARD COMMENTS 2 02/25/20 PER CONSULTANT COMMENTS

1182 NORTH AVENUE SITE PLAN AND SPECIAL USE PERMIT

1182 NORTH AVENUE

CITY OF BEACON, DUTCHESS COUNTY, NEW YORK TAX ID: 5955-19-738049 & 5955-19-747060 LOT AREA: ±0.68 ACRES TOTAL R1-7.5 ZONING DISTRICT AND HISTORIC



AREA MAP

BEFORE UNDERTAKING ANY DIGGING, DRILLING,

BLASTING OR DISTURBANCE TO THE GROUND IN

ANY WAY, FOR ANY REASON, ALL INDIVIDUALS

MUST CONTACT

DIG SAFELY NEW YORK

811 OR WWW.CALL811.COM

OWNER & APPLICANT:

ANDREW MACDONALD 97 ROOSEVELT DRIVE POUGHQUAG, NY 12570 PHONE: 914-645-4351

PROJECT ENGINEER:

HUDSON LAND DESIGN PROFESSIONAL ENGINEERING P.C. 174 MAIN STREET BEACON, NEW YORK 12508 PH: 845-440-6926

F: 845-440-6637

PROJECT SURVEYOR:

SCALE: 1" = 100

HUDSON LAND DESIGN

PROFESSIONAL ENGINEERING P.C.

174 MAIN ST., BEACON, NEW YORK 12508

13 CHAMBERS ST., NEWBURGH, NEW YORK 12550

PH: 845-440-6926

F: 845-440-6637

DECKER SURVEYING JOHN H. DECKER LS 290 FRALEIGH LANE RED HOOK, NEW YORK 12571 PH: 845-758-4442

PROJECT ARCHITECT: D M FLORANCE ARHCITECTURE PLLC DOUGLAS M. FLORANCE R.A A.I.A. 6 GRIFFIN STREET POUGHQUAG, NY 12570

PH: 845-227-8516

CONSTRUCTION SEQUENCING SCHEDULE:

6. REMOVE SILT FENCE WHEN 80% STABILIZATION IS ACHIEVED.

1. ROUGH GRADE AS NECESSARY TO ESTABLISH DRIVEWAY GRADE. PREPARE A STABILIZED CONSTRUCTION ENTRANCE AS SHOWN.

2. INSTALL SILT FENCE PER THE PLAN AND AS NEEDED TO PROTECT THE ADJACENT PROPERTIES. 3. CONSTRUCT THE HOUSE AND ALL ASSOCIATED UTILITY SERVICE CONNECTIONS. FINE GRADE AROUND THE HOUSE TO ESTABLISH FINISHED GRADES 4. TOPSOIL, SEED AND MULCH THE DISTURBED AREAS TO ESTABLISH VEGETATION. 5. REMOVE THE STABILIZED CONSTRUCTION ENTRANCE AND CONSTRUCT THE DRIVEWAY TO FINAL TOP TREATMENT.

PARKING NOTES:

1. REQUIRED PARKING = 2 SPACES PER SINGLE FAMILY RESIDENTIAL, PLUS 2 SPACES FOR PER ACCESSORY APARTMENT = 4 SPACES REQUIRED. 2. THE PROPOSED PARKING ARRANGEMENT CONSISTS OF 4 SPACES IN THE PARKING AREA TO THE NORTH OF THE PROPOSED STRUCTURE AND 2 SPACES IN THE PROPOSED GARAGE FOR A TOTAL OF 4 SPACES.

UTILITY NOTES:

1. ALL WATER & SEWER CONNECTIONS SHALL COMPLY WITH CITY WATER AND SEWER DISTRICT REQUIREMENTS. 2. THE PROPOSED BUILDING SHALL BE SET AT SUCH ELEVATION TO ENSURE GRAVITY FLOW FROM THE RAW SEWER LINE TO THE POINT OF CONNECTION WITH THE EXISTING SEWER MAIN, WHILE MAINTAINING PROPER EARTH COVER ABOVE ALL PIPING. 3. NO CELLAR, ROOF, OR FOOTING DRAINS SHALL BE DISCHARGED INTO THE SANITARY SEWER SYSTEM.

EROSION AND SEDIMENT CONTROL NOTES:

1. ALL EROSION CONTROL MEASURES EMPLOYED DURING THE CONSTRUCTION PROCESS SHALL BE INSPECTED BY THE CONTRACTOR IN ACCORDANCE WITH THE MAINTENANCE SCHEDULE. ALL EROSION CONTROL STRUCTURES SHALL BE REPAIRED AND MAINTAINED AS NECESSARY BY THE CONTRACTOR. 2. ALL STORMWATER MANAGEMENT STRUCTURES (E.G. CATCH BASINS) SHALL BE REGULARLY INSPECTED FOR SEDIMENT ACCUMULATIONS. CATCH BASINS SHALL BE CLEANED WHEN SEDIMENT DEPTH REACHES A MAXIMUM OF ONE—HALF THE AVAILABLE SUMP DEPTH. 3. ALL EROSION CONTROL INSTALLATION AND MAINTENANCE MEASURES SHALL MEET THE REQUIREMENTS OF THE NEW YORK STANDARDS AND SPECIFICATIONS FOR EROSION AND SEDIMENT CONTROL. 4. ANY PILE OF POTENTIALLY EROSIVE MATERIAL TEMPORARILY STOCKPILED ON THE SITE DURING THE CONSTRUCTION PROCESS SHALL BE LOCATED IN AN AREA AWAY FROM STORM DRAINAGE AND SHALL BE PROPERLY PROTECTED FROM EROSION BY A SURROUNDING SILT

PERMANENT SEEDED AREAS FOR EROSION CONTROL SHALL BE IN ACCORDANCE WITH DETAIL AND SPECIFICATIONS ON THIS PLAN. AREAS UNDERGOING CLEARING OR GRADING AND WHERE WORK IS DELAYED OR COMPLETED AND WILL NOT BE REDISTURBED FOR A PERIOD OF 21 DAYS OR MORE SHALL BE STABILIZED WITH TEMPORARY OR PERMANENT VEGETATIVE COVER WITHIN 14 DAYS. ON-SITE DUST CONTROL SHALL BE ACCOMPLISHED BY STANDARD METHODS OF LIGHTLY WATERING ALL EXPOSED SOIL AND RAPIDLY STABILIZING THE REGRADED AREAS WITH TOPSOIL, LOAM AND/OR SEEDING. 8. THE CITY ENGINEER AND PROJECT ENGINEER SHALL BE NOTIFIED NO LESS THAN 48 HOURS PRIOR TO THE START OF ANY SITE WORK, AND BY SUCH NOTIFICATION, SHALL BE PROVIDED WITH THE NAME AND TELEPHONE NUMBER OF THE GENERAL CONTRACTOR RESPONSIBLE FOR SUCH

9. THE CITY AND/OR ITS REPRESENTATIVES MAY INSPECT EROSION AND SEDIMENT CONTROL PRACTICES ON THE SITE DURING CONSTRUCTION AND RECOMMEND THAT THE CONTRACTOR INSTALL ADDITIONAL EROSION CONTROL MEASURES IF DEEMED NECESSARY TO PROTECT ANY UNDISTURBED AREAS OF THE SITE. ANY SUCH REQUESTS SHALL BE MADE DIRECTLY TO THE CONTRACTOR AND QUALIFIED PROFESSIONAL AND FOLLOWED UP WITH A WRITTEN NOTIFICATION TO THE DEVELOPER. IN ADDITION, THE PROJECT ENGINEER SHALL BE CONSULTED ON ANY SPECIAL ADDITIONS OR DELETIONS OF EROSION CONTROL MEASURES WARRANTED BY CHANGING FIELD CONDITIONS. 10. IF GROUNDWATER IS ENCOUNTERED DURING CONSTRUCTION ACTIVITIES, THE CONTRACTOR SHALL CONSTRUCT A DEWATERING PIT IN ACCORDANCE WITH NEW YORK STANDARDS AND SPECIFICATIONS FOR EROSION AND SEDIMENT CONTROL TO FILTER WATER FOR PUMPING TO A 11. WHEN ALL DISTURBED AREAS ARE STABLE, ALL TEMPORARY EROSION AND SEDIMENT CONTROL MEASURES SHALL BE REMOVED.

INSPECTION SCHEDULE & MAINTENANCE OF EROSION AND SEDIMENT CONTROL MEASURES

PERMANENT AND TEMPORARY VEGETATION:
INSPECT ALL AREAS THAT HAVE RECEIVED VEGETATION EVERY SEVEN DAYS AND AFTER EVERY STORM EVENT WITH RAINFALL THAT EQUALS OR EXCEEDS 0.5 INCH. ALL AREAS DAMAGED BY EROSION OR WHERE SEED HAS NOT ESTABLISHED SHALL BE REPAIRED AND RESTABILIZED IMMEDIATELY.

STABILIZED CONSTRUCTION ENTRANCE:
INSPECT THE ENTRANCE PAD EVERY SEVEN DAYS AND AFTER EVERY STORM EVENT WITH RAINFALL THAT EQUALS OR EXCEEDS 0.5 INCH. CHECK FOR MUD, SEDIMENT BUILD-UP AND PAD INTEGRITY. MAKE DAILY INSPECTIONS DURING WET WEATHER, REGRADE PAD AS NEEDED FOR RUNOFF CONTROL. WASH AND REPLACE STONE AS NEEDED. THE STONE IN THE ENTRANCE SHOULD BE WASHED OR REPLACED WHENEVER THE ENTRANCE FAILS TO REDUCE MUD BEING CARRIED OFF SITE BY VEHICLES. IMMEDIATELY REMOVE MUD AND SEDIMENT TRACKED OR WASHED ONTO PUBLIC ROADS BY BRUSHING OR SWEEPING. REMOVE TEMPORARY CONSTRUCTION ENTRANCE AS SOON AS THEY ARE NO LONGER NEEDED TO PROVIDE ACCESS TO THE SITE AS DIRECTED BY PROJECT ENGINEER.

INSPECT FOR DAMAGE EVERY SEVEN DAYS AND AFTER EVERY STORM EVENT WITH RAINFALL THAT EQUALS OR EXCEEDS 0.5 INCH. MAKE ALL REPAIRS IMMEDIATELY. REMOVE SEDIMENT FROM THE UP-SLOPE FACE OF THE FENCE BEFORE IT ACCUMULATES TO A HEIGHT EQUAL TO ONE-QUARTER THE HEIGHT OF THE FENCE. IF FENCE FABRIC TEARS, BEGINS TO DECOMPOSE, OR IN ANY WAY BECOMES INEFFECTIVE, REPLACE THE AFFECTED SECTION

INSPECT SEDIMENT CONTROL BARRIERS (SILT FENCE) AND VEGETATION FOR DAMAGE EVERY SEVEN DAYS AND AFTER EVERY STORM EVENT WITH RAINFALL THAT EQUALS OR EXCEEDS 0.5 INCH. MAKE ALL REPAIRS IMMEDIATELY. REMOVE SEDIMENT FROM THE UP-SLOPE FACE OF THE SEDIMENT CONTROL BARRIER BEFORE IT ACCUMULATES TO A HEIGHT EQUAL TO ONE-QUARTER THE HEIGHT OF THE SEDIMENT CONTROL BARRIER. IF SEDIMENT CONTROL BARRIER TEARS, BEGINS TO DECOMPOSE, OR IN ANY WAY BECOMES INEFFECTIVE, REPLACE THE AFFECTED SECTION OF SEDIMENT CONTROL BARRIER IMMEDIATELY. REVEGETATE DISTURBED AREA TO STABILIZE SOIL STOCKPILE. REMOVE THE SEDIMENT CONTROL BARRIER WHEN THE SOIL

<u>DUST CONTROL:</u>
SCHEDULE CONSTRUCTION OPERATIONS TO MINIMIZE THE AMOUNT OF DISTURBED AREAS AT ANY ONE TIME DURING THE COURSE OF WORKS. APPLY TEMPORARY SOIL STABILIZATION PRACTICES SUCH AS MULCHING, SEEDING, AND SPRAYING (WATER). STRUCTURAL MEASURES (MULCH, SEEDING) SHALL BE INSTALLED IN DISTURBED AREAS BEFORE SIGNIFICANT BLOWING PROBLEMS DEVELOP. WATER SHALL BE SPRAYED AS NEEDED. REPEAT AS NEEDED, BUT AVOID EXCESSIVE SPRAYING, WHICH COULD CREATE RUNOFF AND EROSION PROBLEMS.

APPROVED BY RESOLUTION OF THE	PLANNING F	BOARD OF	THE CIT	Y OF BI	EACON,	NEW	YORK,	ON
DAY OF		, 20	, S	UBJECT	TO ALL	. REQL	JIREMEI	NTS
STATED THEREIN.								
SIGNED THIS	_ DAY OF _			, 20	, BY			
CHAIRMAN, CITY PLANNING BOARD				D	 ATE			

OWNER'S CONSENT: THE UNDERSIGNED OWNER OF THE PROPERTY HEREON STATES THAT HE IS FAMILIAR WITH THIS MAP, ITS CONTENTS AND ITS LEGENDS AND HEREBY CONSENTS TO ALL SAID TERMS AND CONDITIONS AS STATED HEREON.

ANDREW G. MACDONALD

DATE

COVER SHEET

1182 NORTH AVENUE

1182 NORTH AVENUE (NYS ROUTE 9D) CITY OF BEACON DUTCHESS COUNTY, NEW YORK

TAX ID: 5955-19-738049 & 5955-19-747060

SHEET: 1 OF 6

JOB #: 2019:021

DATE: 10/29/19

SCALE: AS SHOWN

TITLE: CV-1

UNAUTHORIZED ALTERATIONS OR ADDITIONS TO THIS DRAWING IS A VIOLATION OF SECTION 7209.2 OF THE NEW YORK EDUCATION LAW



LEGEND:

EXISTING PROPERTY LINE — — — — — — — ADJOINING PROPERTY LINE ----- EXISTING MAJOR CONTOUR ---- EXISTING MINOR CONTOUR EXISTING UTILITY POLE ----- OHW------- OHW------ EXISTING OVERHEAD WIRE ----- WTR ------ WTR ----- EXISTING WATER MAIN EXISTING WATER VALVE EXISTING HYDRANT EXISTING SEWER MANHOLE - EXISTING SEWER MAIN — — — — — — — EXISTING STORMWATER LINE

EXISTING BUILDINGS

EXISTING SIDEWALK AREA EXISTING BUILDING AREA

TO BE REMOVED

PROJECT INFORMATION: PARCEL OWNER: ANDREW MACDONALD; 97 ROOSEVELT DRIVE, POUGHQUAG NY 12570 ENGINEER OF RECORD: HUDSON LAND DESIGN P.C., 174 MAIN STREET, BEACON NY 12508 D M FLORANCE ARCHITECTURE PLLC; 6 GRIFFIN ST, POUGHQUAG NY 12570 ARCHITECT OF RECORD: SURVEYOR OF RECORD: DECKER SURVEYING; 290 FRALEIGH LANE, RED HOOK NY 12571 PROJECT LOCATION: 1182 NORTH AVENUE, BEACON NY 12508 TAX PARCEL ID: CITY OF BEACON - 5955-19-738049 & 5955-19-747060 PARCEL AREA: 0.68 ACRES TOTAL R1-7.5 ZONING DISTRICT ZONING DISTRICT: POTABLE WATER SUPPLY: MUNICIPAL WATER MUNICIPAL SEWER SEWAGE DISPOSAL:

OWNER'S CONSENT:

THE UNDERSIGNED OWNER OF THE PROPERTY HEREON STATES THAT HE IS FAMILIAR WITH THIS MAP, ITS CONTENTS AND ITS LEGENDS AND HEREBY CONSENTS TO ALL SAID TERMS AND CONDITIONS AS STATED HEREON.

LAND DESIGN

ANDREW G. MACDONALD

APPROVED BY RESOLUTION OF THE PLANNING BOARD OF THE CITY OF BEACON, NEW YORK, ON THE _, 20_____, SUBJECT TO ALL REQUIREMENTS AS STATED THEREIN.

JOB #: 2019:021

DATE: 10/29/19

SCALE: 1" = 20'

TITLE: XC-1

SHEET: 2 OF 6

CHAIRMAN, CITY PLANNING BOARD

EXISTING CONDITIONS & REMOVAL PLAN

1182 NORTH AVENUE


1182 NORTH AVENUE CITY OF BEACON DUTCHESS COUNTY, NEW YORK

TAX ID: 5955-19-738049 & 5955-19-747060

F: 845-440-6637

HUDSON LAND DESIGN PROFESSIONAL ENGINEERING P.C. 174 MAIN ST., BEACON, NEW YORK 12508 13 CHAMBERS ST., NEWBURGH, NEW YORK 12550 PH: 845-440-6926

UNAUTHORIZED ALTERATIONS OR ADDITIONS TO THIS DRAWING IS A VIOLATION OF SECTION 7209.2 OF THE NEW YORK EDUCATION LAW

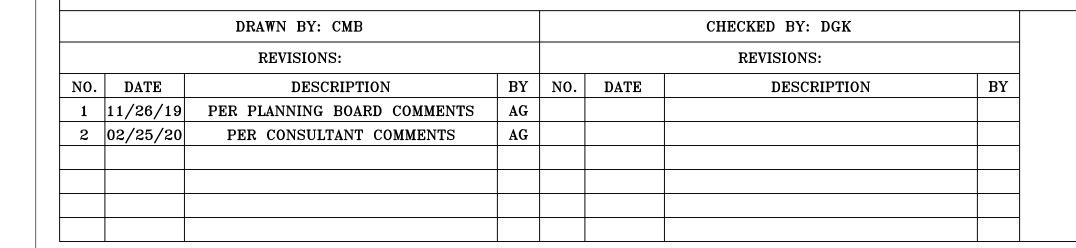


BEFORE UNDERTAKING ANY DIGGING, DRILLING, BLASTING OR DISTURBANCE TO THE GROUND IN ANY WAY, FOR ANY REASON, ALL INDIVIDUALS MUST CONTACT

DIG SAFELY NEW YORK 811 OR WWW.CALL811.COM





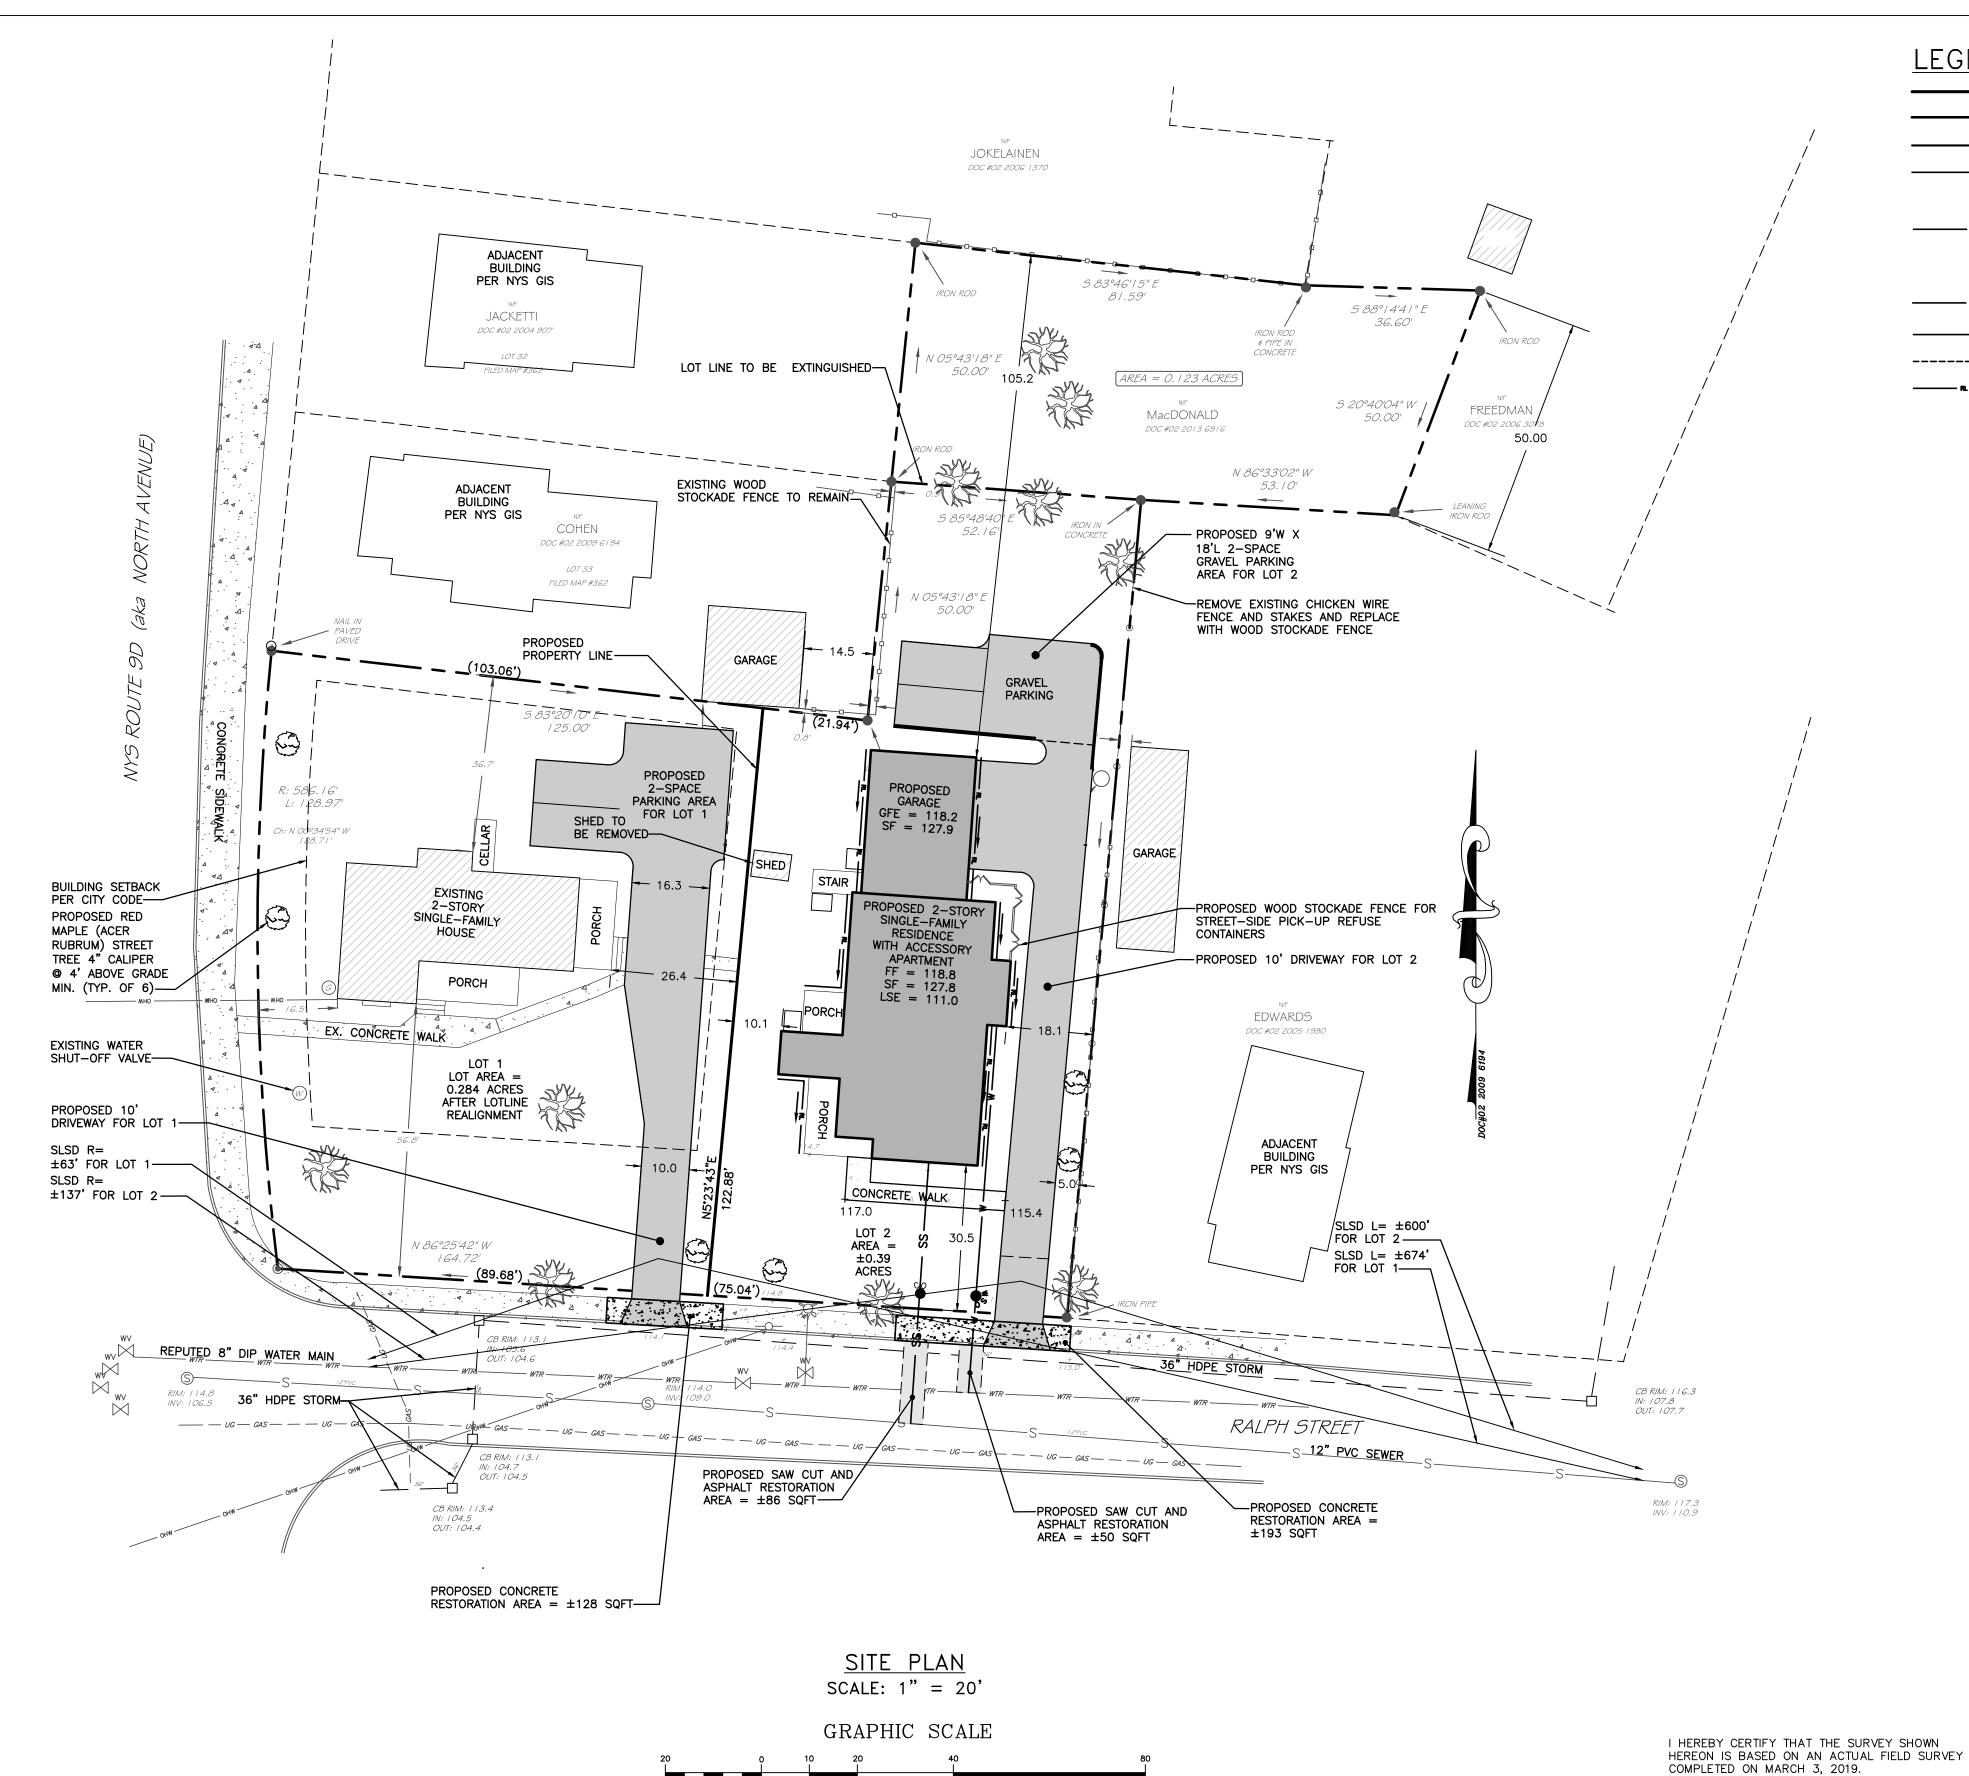

(IN FEET) 1 inch = 20 ft. LEGEND:

PROPOSED PROPERTY LINE EXISTING PROPERTY LINE - PROPOSED MAJOR CONTOUR - PROPOSED MINOR CONTOUR 112.5 PROPOSED SPOT ELEVATION - WS----- PROPOSED WATER SERVICE LINE PROPOSED WATER SHUTOFF VALVE

--- ST ------ PROPOSED CULVERT ----- PROPOSED UNDERDRAIN

PROPOSED ROOF LEADER PIPE PROPOSED ROOF LEADER LOCATION

PROPOSED CLEANOUT

EXISTING BUILDING AREA

ASPHALT AREA EXISTING SIDEWALK AREA MAP REFERENCES:

1. EXISTING FEATURES AS SHOWN ON THIS SUBDIVISION PLAN PROVIDED BY MAPPING OBTAINED FROM DECKER SURVEYING, LLC.

SITE SPECIFIC NOTES:

1. THE CONTRACTOR SHALL PERFORM A UTILITIES CALL-OUT PRIOR TO CONSTRUCTION TO VERIFY ALL UNDERGROUND UTILITY LOCATIONS BY CONTACTING UFPO @ 1-800-962-7962. SPECIFIC ATTENTION SHALL BE PAID TO THE LOCATIONS OF THE GAS (IF APPLICABLE), WATER AND SEWER MAINS WITH

RESPECT TO THE PROPOSED LOCATIONS FOR THE SERVICE LINES. 2. THE CONTRACTOR SHALL CONTACT THE CITY OF BEACON WATER AND SEWER DEPARTMENTS TO SCHEDULE A PRE-CONSTRUCTION MEETING TO ENSURE THAT THE ARRANGEMENTS FOR WATER SUPPLY AND SEWAGE DISPOSAL ARE COMMENCED IN ACCORDANCE WITH THE APPROVED PLANS AND AMENDMENTS THERETO AND GENERALLY ACCEPTED STANDARDS.

3. THE PROPOSED LOT SHALL BE SERVED BY THE CITY OF BEACON MUNICIPAL WATER AND SEWER SERVICES. 4. THE WATER SERVICE LINE AND METER SHALL BE INSTALLED IN ACCORDANCE WITH THE CITY OF

BEACON WATER DEPARTMENT REQUIREMENTS. 5. THE WATER SERVICE LINE SHALL BE 3/4" Ø K-COPPER.

6. THE SEWER SERVICE LINE SHALL BE 4"0 SDR 35 PVC PIPE WITH PITCH AS SHOWN ON THE PLAN (MINIMUM OF 1/4" PER FOOT SHALL BE MAINTAINED).

7. A ROAD OPENING PERMIT SHALL BE REQUIRED FOR THE INSTALLATION OF THE PROPOSED WATER AND SEWER SERVICES FOR THE NEW LOT. STREET CLOSURE FOR WATER AND SEWER SERVICE CONNECTIONS SHALL BE PERFORMED IN ACCORDANCE WITH CITY OF BEACON REQUIREMENTS.

8. ALL EROSION CONTROL MEASURES SHALL BE INSTALLED PRIOR TO CONSTRUCTION. THE PROPOSED DRIVEWAY SHALL HAVE A STABILIZED CONSTRUCTION ENTRANCE.

9. ROOF LEADER CONNECTIONS TO BE MINIMUM 4" PVC OR HDPE @ 2.0% MIN. 10. SUMP PUMP TO BE PROVIDED FOR FOOTING DRAIN, IF NECESSARY. THE TYPE OF PUMP AND METHODS USED TO ENSURE PROPER DRAINAGE SHALL BE ACCEPTABLE TO THE CITY OF BEACON BUILDING

11. THE DRIVEWAY SIGHT DISTANCE MEETS OR EXCEEDS COMPLIANCE WITH THE CITY OF BEACON'S 192-9(B) CODE AND THE NEW YORK STATE DEPARTMENT OF TRANSPORTATION REQUIREMENTS. THE STATE UTILIZES THE AMERICAN ASSOCIATION OF STATE HIGHWAY AND TRANSPORTATION OFFICIALS (AASHTO) GUIDELINES FOR INTERSECTION SIGHT DISTANCES. FOR ROADS WITH A SPEED LIMIT OF 30 MPH,

RIGHT. THE MEASURED SIGHT DISTANCE IS AS FOLLOWS: LOT 1: SLSD LEFT = ±674 FEET (TO INTERSECTION OF RALPH STREET AND DUTCHESS TERRACE) SLSD RIGHT = ± 63 FEET (TO INTERSECTION OF RALPH STREET AND NYS ROUTE 9D)

AASHTO DESIGN TABLES CALL FOR A SIGHT DISTANCE OF 290 FEET TO THE LEFT AND 335 FEET TO THE

LOT 2: SLSD LEFT = ±600 FEET (TO INTERSECTION OF RALPH STREET AND DUTCHESS TERRACE) SLSD RIGHT = ± 137 FEET (TO INTERSECTION OF RALPH STREET AND NYS ROUTE 9D) STOPPING SIGHT DISTANCE (SSD) WAS OBSERVED TO BE IN EXCESS OF THE REQUIRED 200 FEET WHEN APPROACHING THE PROPOSED DRIVEWAY FOR BOTH LOT 1 AND LOT 2 FROM THE LEFT. SSD FROM THE RIGHT WAS DEFICIENT PER STANDARDS BUT MEASURED TO THE INTERSECTION OF RALPH STREET AND NYS ROUTE 9D.THE SSD AND SLSD RIGHT MEASUREMENTS WERE TAKEN TO THE INTERSECTION OF ROUTE 9D AND RALPH STREET, BUT GOES THROUGH THE INTERSECTION. VEHICLES APPROACHING FROM TOMPKINS AVE ARE STOP CONTROLLED, AND VEHICLES TURNING ONTO RALPH STREET WILL BE ACCELERATING AND NOT AT FULL POSTED SPEED; THEREFORE THE SIGHT DISTANCES ARE DEEMED ACCEPTABLE.

12. VEGETATION ALONG LOT 1 AND LOT 2 FRONTAGE ON RALPH STREET SHALL BE REMOVED TO FACILITATE SIGHT LINE SIGHT DISTANCES FOR THE PROPOSED DRIVEWAYS. 13. THE CONTRACTOR SHALL FIELD VERIFY THE LOCATIONS AND INVERTS OF ALL CATCH BASINS, STORM

SEWER LINES, SANITARY MANHOLES, SEWER LINES, WATERLINES, AND UNDERGROUND UTILITY LINES PRIOR TO CONSTRUCTION. THE CONTRACTOR SHALL NOT ASSUME THAT ALL LOCATIONS AS SHOWN ON THE PLAN ARE CORRECT. INVESTIGATIVE TEST PITS MAY BE REQUIRED TO VERIFY LOCATIONS.

SCHEDULE OF REGULATIONS (R1-7.5 ZONING									
DISTRICT) AND LOT CONFORMANCE TABLE:									
PARAMETER	REQUIREMENT	LOT 1	LOT 2						
LOT AREA:	7,500 S.F.	12,391 S.F.	17,082 S.F.						
LOT WIDTH:	75 FT	±101 FEET	±75.1 FEET						
LOT DEPTH:	100 FT	±127.8 FEET	±221 FEET						
YARD SETBACKS:									
FRONT YARD:	30 FEET MINIMUM	56.8 FEET	30.5 FEET						
SIDE YARDS/TOTAL OF 2:	10 FEET MINIMUM/20 FEET	16.5/42.9 FEET	10.1/28.2 FEET						
REAR YARD:	30 FEET MINIMUM	36.7 FEET	105.2 FEET						
BUILDING COVERAGE:	MAX 30%	11.7%	15.8%						

OWNER'S CONSENT:

THE UNDERSIGNED OWNER OF THE PROPERTY HEREON STATES THAT HE IS FAMILIAR WITH THIS MAP, ITS CONTENTS AND ITS LEGENDS AND HEREBY CONSENTS TO ALL SAID TERMS AND CONDITIONS AS STATED HEREON.

ANDREW G. MACDONALD

_____ DAY OF _____, 20____, SUBJECT TO ALL REQUIREMENTS AND CONDITIONS OF SAID RESOLUTION. ANY CHANGE, ERASURE, MODIFICATION OR REVISION OF THIS PLAT, AS APPROVED, SHALL VOID THIS APPROVAL. SIGNED THIS _____, 20____, BY _____ CHAIRMAN

APPROVED BY RESOLUTION OF THE PLANNING BOARD OF THE CITY OF BEACON, NEW YORK, ON THE

___ SECRETARY

IN ABSENCE OF THE CHAIRMAN OR SECRETARY, THE ACTING CHAIRMAN OR ACTING SECRETARY RESPECTIVELY MAY SIGN IN THIS PLACE.

	DRAWN BY: CMB REVISIONS:			CHECKED BY: DGK					
				REVISIONS:					
NO.	DATE	DESCRIPTION	BY	NO.	DATE	DESCRIPTION	BY		
1	11/26/19	PER PLANNING BOARD COMMENTS	AG						
2	02/25/20	PER CONSULTANT COMMENTS	AG						

BEFORE UNDERTAKING ANY DIGGING, DRILLING, BLASTING OR DISTURBANCE TO THE GROUND IN ANY WAY, FOR ANY REASON, ALL INDIVIDUALS MUST CONTACT DIG SAFELY NEW YORK 811 OR WWW.CALL811.COM





JOHN DECKER, LLS, NYS LIC. #050572



HUDSON LAND DESIGN PROFESSIONAL ENGINEERING P.C. 174 MAIN ST., BEACON, NEW YORK 12508 13 CHAMBERS ST., NEWBURGH, NEW YORK 12550 PH: 845-440-6926 F: 845-440-6637

SITE PLAN

1182 NORTH AVENUE

1182 NORTH AVENUE CITY OF BEACON DUTCHESS COUNTY, NEW YORK TAX ID: 5955-19-738049 & 5955-19-747060

SHEET: 3 OF 6 UNAUTHORIZED ALTERATIONS OR ADDITIONS TO THIS DRAWING IS A VIOLATION OF SECTION 7209.2 OF THE NEW YORK EDUCATION LAW


JOB #: 2019:021

DATE: 10/29/19

SCALE: 1" = 20'

TITLE: SP-1



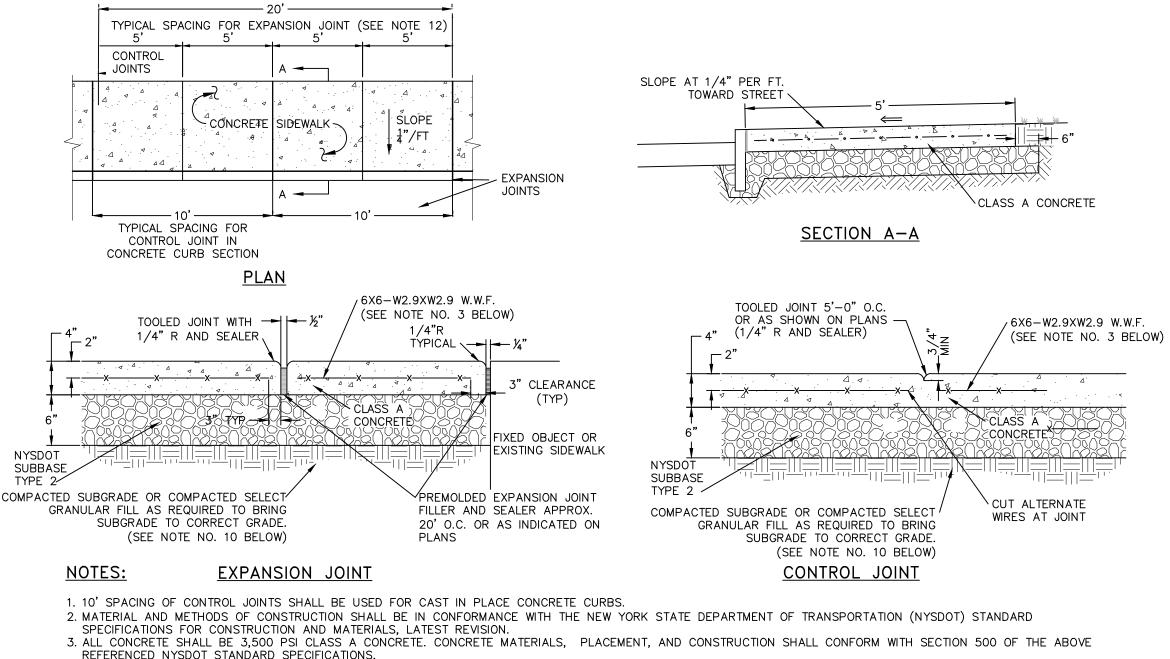


4. REINFORCING STEEL FOR CONCRETE SHALL CONFORM WITH SECTION 556 - REINFORCING STEEL FOR CONCRETE STRUCTURES OF THE ABOVE REFERENCED NYSDOT

8. EXPOSED CONCRETE SURFACES SHALL BE TREATED WITH "SUREBOND"/"SAFEBOND" SB-7000 INTENSIFIER BRIGHT PROTECTOR AND SIDEWALK SEALER, OR EQUAL. RATE

10. WHERE IT IS NECESSARY TO PLACE FILL FOR PURPOSE OF BRINGING THE SUBGRADE ELEVATION UP TO A SPECIFIED GRADE, THE FILL MATERIAL PLACED SHALL BE IN

11. ALL WORK SHALL CONFORM WITH SECTION 608-SIDEWALK, DRIVEWAYS, AND BICYCLE PATHS OF THE ABOVE REFERENCED NYSDOT STANDARD SPECIFICATIONS.

12. SPACING OF EXPANSION JOINTS ON CONCRETE RESTORED SIDEWALKS SHALL MATCH THE CURRENT SPACING OF EXPANSION JOINTS ON EXISTING SIDEWALK. CONCRETE SIDEWALK DETAIL NOT TO SCALE

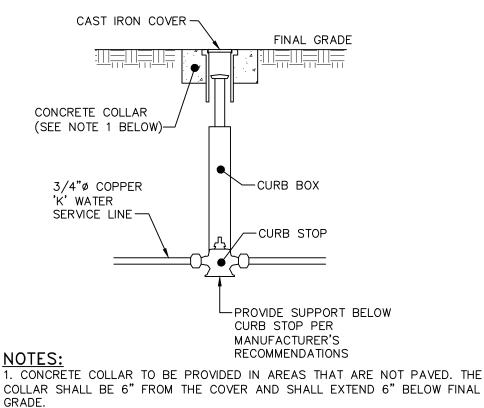

STANDARD SPECIFICATIONS AND AS SPECIFICALLY CALLED OUT IN THE DRAWINGS.

6. EXPANSION JOINTS SHALL BE LOCATED A MAXIMUM OF 20'-0" ON CENTER, OR AS INDICATED ON PLANS.

AND METHOD OF APPLICATION SHALL BE IN ACCORDANCE WITH MANUFACTURE'S RECOMMENDATIONS.

9. SUBBASE MATERIAL SHALL CONFORM WITH SECTION 304 OF THE ABOVE REFERENCED NYSDOT STANDARD.


CONFORMATION WITH SECTION 203-EXCAVATION AND EMBANKMENT OF THE ABOVE REFERENCED NYSDOT STANDARD SPECIFICATIONS.

5.ALL EXPOSED SURFACED SHALL HAVE A BROOM TEXTURED FINISH.

7. JOINTS SHALL NOT BE SAW CUT.


3. AREA AROUND CURB BOX TO BE BACKFILLED WITH GRAVELLY MATERIAL. WATER SHUT-OFF VALVE DETAIL NOT TO SCALE


2. CURB STOP TO BE COMPRESSION TYPE BY MUELLER.

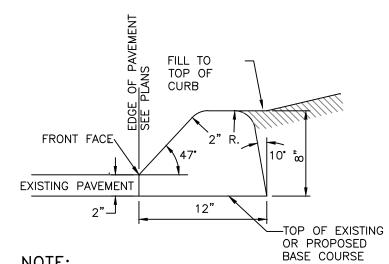


DIMENSIONS SHOWN ARE STANDARD. ADJUSTMENTS TO THE ABOVE DIMENSIONS SHALL BE MADE TO MATCH EXISTING ASPHALT CURB.

> ASPHALT CURB DETAIL NOT TO SCALE

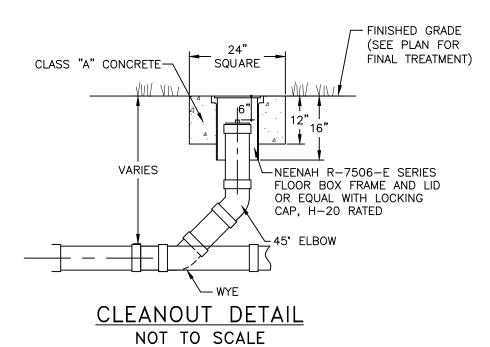

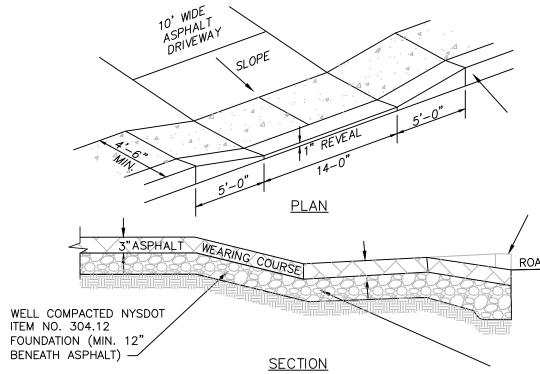

NOTE:
1. RESEED AND STABILIZE GRASS AREAS AFTER ASPHALT AND CONCRETE INSTALLATION. LOT 1 & 2 DRIVEWAY ENTRANCE DETAIL NOT TO SCALE

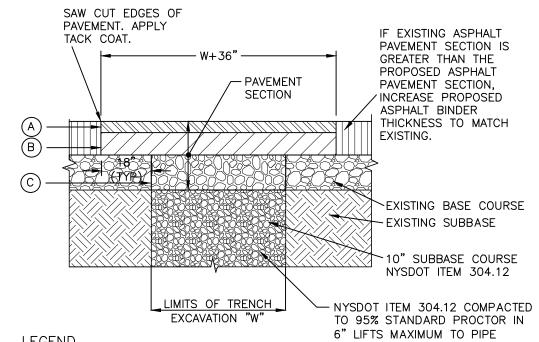


<u>LEGEND</u> (A) 1.5" ASPHALT CONCRETE TOP COURSE- NYSDOT TYPE F1 3.0" ASPHALT CONCRETE BINDER COURSE- NYSDOT TYPE F9

C) 3.0" ASPHALT BASE COURSE- NYSDOT TYPE F9


NOTES:

- 1. SAW CUT MIN. 18" BEYOND EXCAVATION WITH SMOOTH EDGES. 18" JOINT BETWEEN EXISTING AND NEW TOP COURSE TO BE MILLED. JOINT TO BE SEALED WITH POLYMER MODIFIED SEALER.
- 2. FURNISH. PLACE, AND COMPACT SUBBASE. 3. TACK COAT IN ACCORDANCE WITH NYSDOT STANDARD SPEC. 4. FURNISH AND PLACE ASPHALT CONCRETE PAVEMENT AS SPECIFIED.

PAVEMENT RESTORATION DETAIL NOT TO SCALE

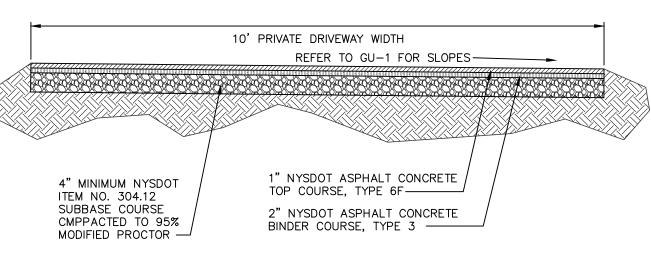

PAVED DRIVEWAY SECTION DETAIL NOT TO SCALE

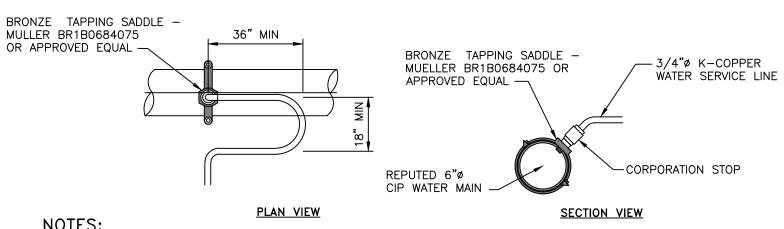


1. A MINIMUM 5' COVER SHALL BE PROVIDED ON THE WATER SERVICE LINE (CONDITIONED ON ACTUAL WATER MAIN

2. CORPORATION STOP TO BE COMPRESSION TYPE BY MUELLER. 3. WATER SERVICE LINE TO HAVE A 'GOOSENECK' NEAR CORPORATION STOP.

4. CORPORATION STOP TO BE INSTALLED IN THE UPPER HALF OF THE WATER MAIN AT AN ANGLE OF APPROXIMATELY 45° FROM HORIZONTAL. 5. THE CONTRACTOR SHALL INSTALL A FULL BODIED STAINLESS STEEL TAPPING SLEEVE AT THE PROPOSED WATER SERVICE LOCATION.


WATER SERVICE CONNECTION DETAIL NOT TO SCALE

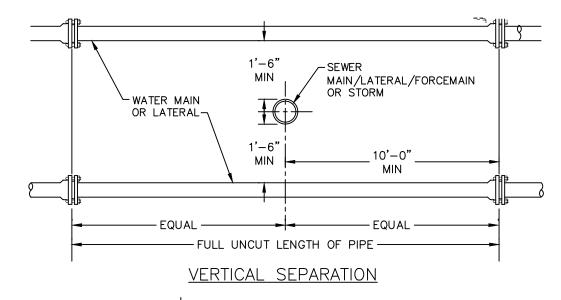

WATER MAIN MAIN/LATERAL/FORCEMAIN. — (+ +) OR SERVICE STORM LINE & MANHOLES HORIZONTAL SEPARATION


NOTE: 1. NO DEVIATION IN THE SEPARATION REQUIREMENTS WILL BE PERMITTED WITHOUT THE EXPRESS APPROVAL OF THE DUTCHESS COUNTY DEPARTMENT OF HEALTH AND THE CITY OF BEACON. CONCRETE ENCASEMENT OF WATERLINE OR OFFSETTING OF WATERLINE SHALL BE REQUIRED WHERE SEPARATION DISTANCES CANNOT BE MAINTAINED.

WATER LINE SEPARATION DETAIL NOT TO SCALE

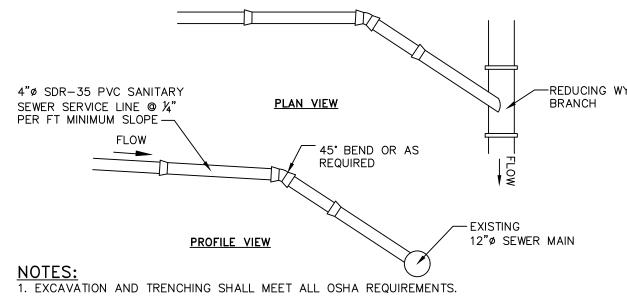


3. TAPPING SADDLE FOR CONNECTION OF THE PROPOSED SERVICE LINE TO THE EXISTING SEWER MAIN TO BE A 4" PREDCO HUB TAP SADDLE - MODEL #HTS4/E.

SANITARY SEWER SERVICE CONNECTION DETAIL NOT TO SCALE

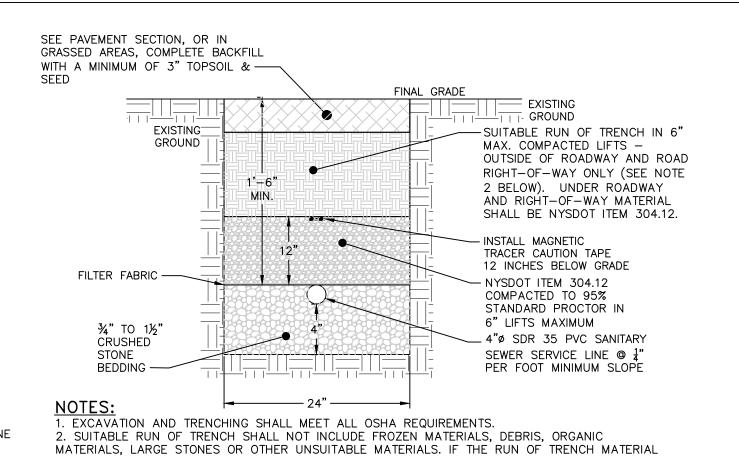

SANITARY SEWER SERVICE
LINE TRENCH DETAIL NOT TO SCALE

IS FOUND TO BE UNSUITABLE, A SUITABLE BACKFILL MATERIAL SHALL BE IMPORTED AND USED.

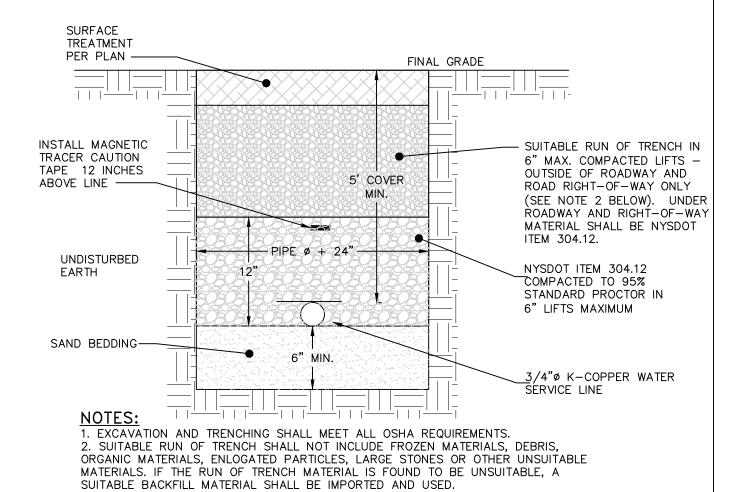

18" OF VERTICAL SEPARATION WATER SERVICE LINE TRENCH DETAIL NOT TO SCALE

SHALL PROVIDE PIPE INSULATION TO PREVENT FREEZING.

3. IN AREAS WHERE 5' COVER REQUIREMENT CANNOT BE MET, THE CONTRACTOR

4. IF WATER SERVICE AND SEWER SERVICE LINE CROSSINGS ARE NEEDED, PROVIDE

4"Ø SDR-35 PVC SANITARY SEWER SERVICE LINE @ 1/4" PER FT MINIMUM SLOPE REDUCING WYE BRANCH
FLOW 45° BEND OR AS REQUIRED
PROFILE VIEW EXISTING 12"ø SEWER MAIN
NOTES:
1. EXCAVATION AND TRENCHING SHALL MEET ALL OSHA REQUIREMENTS. 2. SUITABLE RUN OF TRENCH SHALL NOT INCLUDE FROZEN MATERIALS, DEBRIS, ORGANIC MATERIALS, LARGE STONES OR OTHER UNSUITABLE MATERIALS. IF THE RUN OF TRENCH MATERIAL IS FOUND TO BE UNSUITABLE. A SUITABLE BACKELL MATERIAL SHALL BE IMPORTED AND USED.

DRAWN BY: CMB					CHECKED BY: DGK			
	REVISIONS:			REVISIONS:				
NO.	DATE	DESCRIPTION	BY	NO.	DATE	DESCRIPTION	BY	
1	11/26/19	PER PLANNING BOARD COMMENTS	AG					
2	02/25/20	PER CONSULTANT COMMENTS	AG					

BEFORE UNDERTAKING ANY DIGGING, DRILLING, BLASTING OR DISTURBANCE TO THE GROUND IN ANY WAY, FOR ANY REASON, ALL INDIVIDUALS MUST CONTACT DIG SAFELY NEW YORK

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CONSTRUCTION DETAILS

1182 NORTH AVENUE

1182 NORTH AVENUE CITY OF BEACON DUTCHESS COUNTY, NEW YORK

TAX ID: 5955-19-738049 & 5955-19-747060


TITLE: CD-1SHEET: 5 OF 6


JOB #: 2019:021

DATE: 10/29/19

SCALE: AS SHOWN


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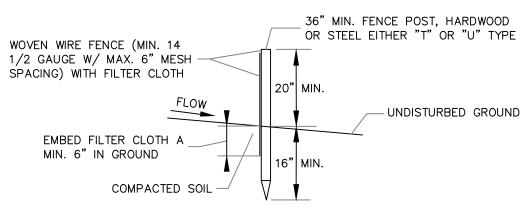


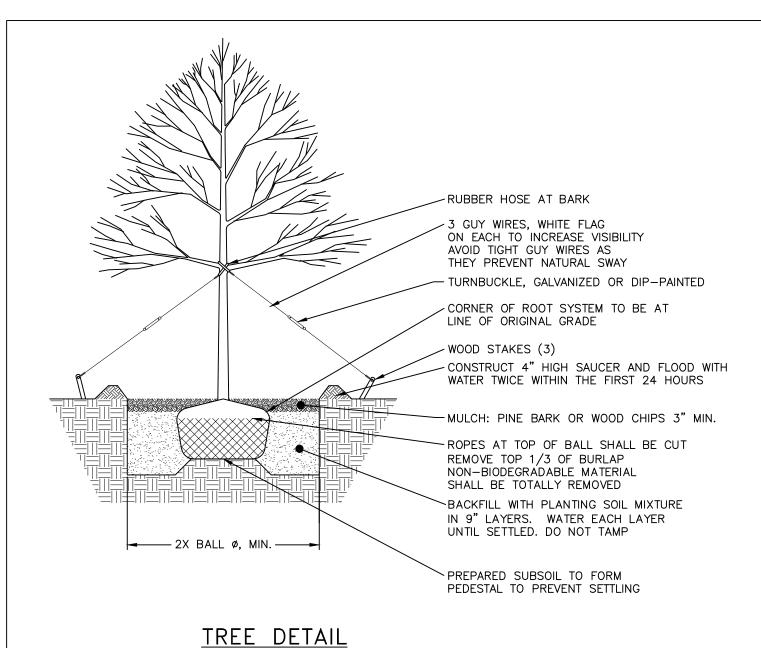

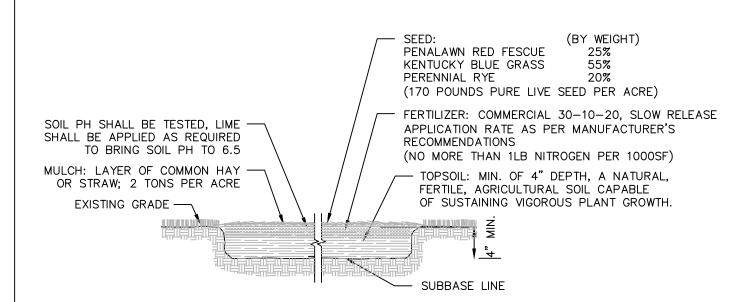NOT TO SCALE

TOPSOIL SEED, FERTILIZER AND MULCH DETAIL NOT TO SCALE



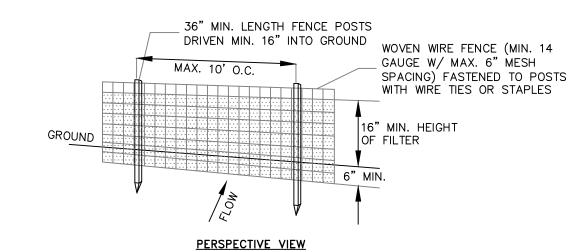


SECTION VIEW

NOTES:


1. FILTER CLOTH TO BE FASTENED SECURELY TO WOVEN WIRE FENCE WITH TIES SPACED EVERY 24" AT TOP AND MID SECTION. 2. WHEN TWO SECTIONS OF FILTER CLOTH ADJOIN EACH OTHER THEY SHALL BE OVER-LAPPED BY SIX INCHES AND FOLDED. FILTER CLOTH SHALL BE EITHER FILTER X, MIRAFI 100X, STABILINKA T140N OR APPROVED EQUAL. 3. PREFABRICATED UNITS SHALL BE GEOFAB, ENVIROFENCE OR APPROVED EQUAL. 4. MAINTENANCE SHALL BE PERFORMED AS NEEDED AND MATERIAL REMOVED WHEN "BULGES" DEVELOP IN THE SILT FENCE.

> SILT FENCE DETAIL NOT TO SCALE

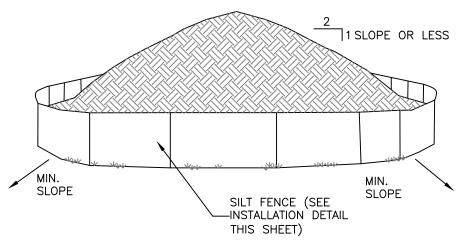


. AREA CHOSEN FOR STOCKPILING OPERATIONS SHALL BE DRY AND 2. EACH PILE SHALL BE SURROUNDED WITH SILT FENCING, THEN STABILIZED WITH VEGETATION OR COVERED.

TEMPORARY SOIL STOCKPILE DETAIL NOT TO SCALE

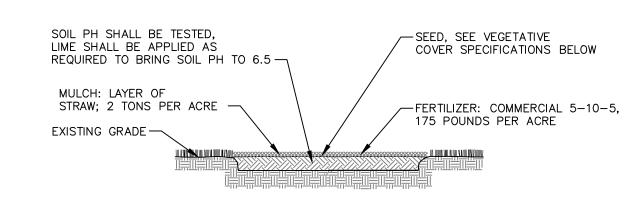


TEMPORARY SEEDING DETAIL NOT TO SCALE

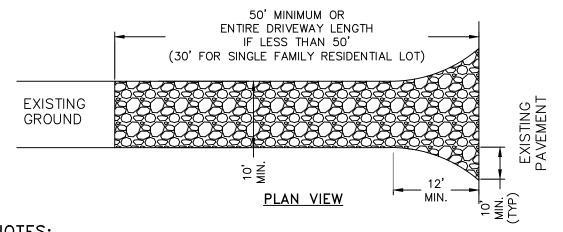

NOTES:

1. STONE SIZE - USE 1-4 INCH STONE, OR RECLAIMED OR RECYCLED CONCRETE EQUIVALENT. 2. THICKNESS - NOT LESS THAN SIX (6) INCHES. 3. WIDTH - 12 FOOT MINIMUM, BUT NOT LESS THAN THE FULL WIDTH AT POINTS WHERE INGRESS OR EGRESS OCCURS. 24 FOOT MINIMUM IF SINGLE ENTRANCE TO LARGE COMMERCIAL OF RESIDENTIAL SITE. 4. GEOTEXTILE - WILL BE PLACED OVER THE ENTIRE AREA PRIOR TO PLACING OF STONE. 5. SURFACE WATER - ALL SURFACE WATER FLOWING OR DIVERTED TOWARD CONSTRUCTION ENTRANCES SHALL BE PIPED BENEATH THE ENTRANCE. IF PIPING IS IMPRACTICAL, A MOUNTABLE BERM WITH 5:1 SLOPES WILL BE PERMITTED 6. MAINTENANCE - THE ENTRANCE SHALL BE MAINTAINED IN A CONDITION WHICH WILL PREVENT TRACKING OR FLOWING OF SEDIMENT ONTO PUBLIC RIGHTS-OF-WAY. THIS MAY REQUIRE PERIODIC TOP DRESSING WITH ADDITIONAL STONE AS CONDITIONS DEMAND AND REPAIR AND/OR CLEANOUT OF ANY MEASURE USED TO TRAP SEDIMENT. ALL SEDIMENT SPILLED, DROPPED, WASHED OR TRACTED ONTO PUBLIC RIGHTS-OF-WAY MUST BE REMOVED IMMEDIATELY. 7. WHEN WASHING IS REQUIRED, IT SHALL BE DONE ON AN AREA STABILIZED WITH STONE AND WHICH DRAINS INTO AN APPROVED SEDIMENT TRAPPING DEVICE. 8. PERIODIC INSPECTION AND NEEDED MAINTENANCE SHALL BE PROVIDED AFTER EACH RAIN.

STABILIZED CONSTRUCTION ENTRANCE DETAIL NOT TO SCALE

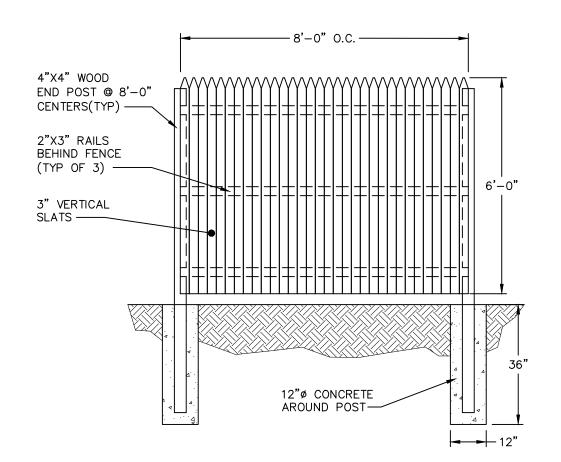

WOOD STOCKADE FENCE DETAIL NOT TO SCALE

APPROVED BY RESOLUTION OF THE PLANNING BOARD OF THE CITY OF BEACON, NEW YORK, ON THE _____ DAY OF _____, 20____, SUBJECT TO ALL REQUIREMENTS AS STATED THEREIN. SIGNED THIS _____, DAY OF ____, 20___, BY

DATE

JOB #: 2019:021

DATE: 10/29/19

DRAWN BY: CMB			CHECKED BY: DGK				
REVISIONS:			REVISIONS:				
NO.	DATE	DESCRIPTION	BY	NO.	DATE	DESCRIPTION	BY
1	11/26/19	PER PLANNING BOARD COMMENTS	AG				
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SCALE: AS SHOWN TITLE: CD-2 SHEET: 6 OF 6

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CHAIRMAN, CITY PLANNING BOARD