


1 inch = 20 ft.

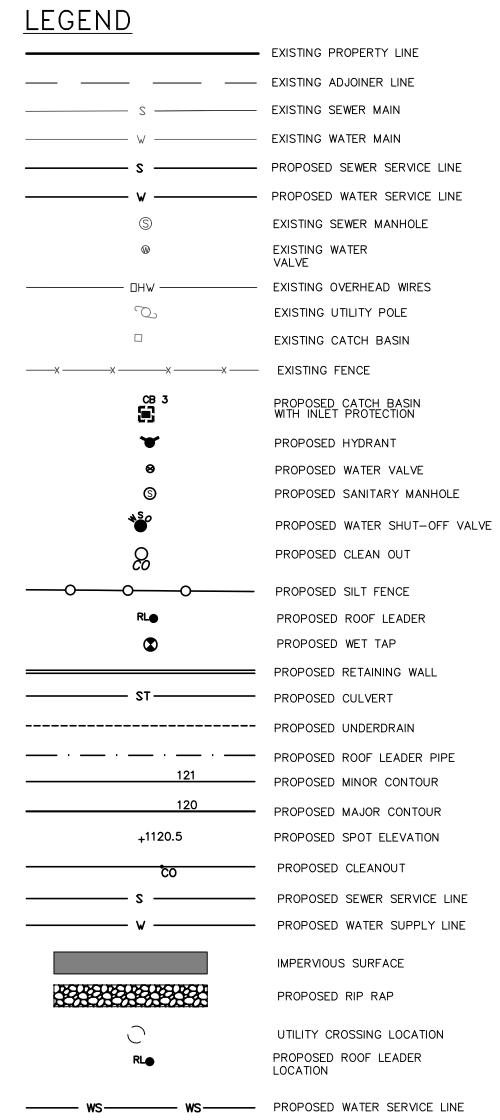

PROJECT INFORMATION: PARCEL OWNER: PIE DEVELOPMENT COMPANY, INC. PROJECT ENGINEER: HUDSON LAND DESIGN P.C., 174 MAIN STREET, BEACON NY 12508 PARCEL LOCATION: 53 ELIZA STREET BEACON, NEW YORK 12508 TAX PARCEL ID: 6054-29-031870 PARCEL AREA: ±0.696-ACRE WATER SUPPLY: MUNICIPAL SEWAGE DISPOSAL: MUNICIPAL ZONING DISTRICT: R-5; R1-7

MAP REFERENCES:

1. EXISTING FEATURES AS SHOWN ON THIS SKETCH PLAN PROVIDED BY A SURVEY BY TECL AND SURVEYING

SITE SPECIFIC NOTES:

1. THE CONTRACTOR SHALL PERFORM A UTILITIES CALL-OUT PRIOR TO CONSTRUCTION TO VERIFY ALL UNDERGROUND UTILITY LOCATIONS BY CONTACTING UFPO @ 1-800-962-7962. SPECIFIC ATTENTION SHALL BE PAID TO THE LOCATIONS OF THE GAS, WATER AND SEWER MAINS WITH RESPECT TO THE PROPOSED LOCATIONS FOR THE SERVICE LINES.

2. THE CONTRACTOR SHALL FIELD VERIFY THE LOCATIONS AND INVERTS OF ALL DRAINAGE, SANITARY

SEWER, WATER AND GAS LINES AND STRUCTURES PRIOR TO CONSTRUCTION. THE CONTRACTOR SHALL NOT ASSUME THAT ALL LOCATIONS AS SHOWN ON THE PLAN ARE CORRECT.

3. THE PROPOSED LOT SHALL BE SERVED BY THE CITY OF BEACON MUNICIPAL WATER AND SEWER SERVICES. AS SUCH, THE CONTRACTOR SHALL CONTACT THE CITY OF BEACON WATER AND SEWER DEPARTMENTS TO SCHEDULE A PRE—CONSTRUCTION MEETING TO ENSURE THAT THE ARRANGEMENTS FOR WATER SUPPLY AND SEWAGE DISPOSAL ARE COMMENCED IN ACCORDANCE WITH THE APPROVED PLANS AND AMENDMENTS THERETO AND GENERALLY ACCEPTED STANDARDS.

4. THE WATER SERVICE LINE AND METER SHALL BE INSTALLED IN ACCORDANCE WITH THE CITY OF

BEACON WATER DEPARTMENT REQUIREMENTS.

5. THE WATER SERVICE LINE SHALL BE 6".Ø DIP.

6. THE SEWER SERVICE LINE SHALL BE 8" ϕ SDR-35 PVC PIPE WITH PITCH AS SHOWN ON THE PLAN (MINIMUM OF χ " PER FOOT SHALL BE MAINTAINED).

7. STREET CLOSURE FOR WATER, SEWER AND GAS SERVICE CONNECTIONS AND DRIVEWAY CONSTRUCTION SHALL BE PERFORMED IN ACCORDANCE WITH CITY OF BEACON REQUIREMENTS. A PLAN SHALL BE IN PLACE FOR MAINTENANCE AND PROTECTION OF TRAFFIC.

8. ALL EROSION CONTROL MEASURES SHALL BE INSTALLED PRIOR TO CONSTRUCTION. MAIN STREET AND NORTH ELM STREET SHALL BE KEPT CLEAN AND SWEPT DURING CONSTRUCTION.

9. SUMP PUMPS TO BE PROVIDED FOR FOOTING DRAINS, AS REQUIRED. THE TYPES OF PUMPS AND

METHODS USED TO ENSURE PROPER DRAINAGE SHALL BE ACCEPTABLE TO THE CITY OF BEACON BUILDING DEPARTMENT.

10. THE TOTAL DISTURBANCE ASSOCIATED WITH THE PROJECT HAS BEEN ESTIMATED TO BE 25,716 SQUARE FFFT (±0.59 ACRE).

SQUARE FEET (±0.59 ACRE).

11. THE BUILDING DEPARTMENT SHALL INSPECT THE EXISTING BUILDING TO CONFIRM THAT THERE ARE NOT EXISTING STORMWATER CONNECTIONS TO THE CITY'S SANITARY SEWER SYSTEM PRIOR TO THE MAP BEING SIGNED.

12. THE EXISTING WATER SERVICE LINE SHALL BE CUT, CAPPED AND ABANDONED IN-PLACE.
13. THE EXISTING SEWER SERVICE LATERAL SHALL BE REMOVED AND PLUGGED TO PREVENT ANY GROUNDWATER INFLOW INTO THE CITY SEWER SYSTEM.

INSPECTION SCHEDULE & LONG TERM MAINTENANCE OF STORMWATER STRUCTURES

CATCH BASINS AND PIPING:

ALL CATCH BASINS SHALL BE INSPECTED AFTER EACH STORM EVENT FOR SEDIMENT ACCUMULATION, AND DEBRIS, AND REMOVE AS NECESSARY. WHEN SEDIMENT ACCUMULATION WITHIN THE CATCH BASIN SUMP REACHES 1/2 OF THE SUMP DEPTH, IT SHALL BE REMOVED. ASSOCIATED PIPING SHALL BE INSPECTED ANNUALLY AND ACCUMULATED SEDIMENT SHALL BE REMOVED AS NEEDED.

| STORM S | EWER STRUCTURE TABLE | | | |
|--|--|--|--|--|
| STRUCTURE | STRUCTURE DETAILS | | | |
| CB 1 | RIM = 137.63 SUMP = 132.70 PIPE 3 INV IN = 133.80 PIPE 4 INV OUT = 133.70 | | | |
| CB 2 | RIM = 139.42 SUMP = 134.94 PIPE 2 INV IN = 136.04 PIPE 5 INV IN = 136.04 PIPE 3 INV OUT = 135.94 | | | |
| CB 3 | RIM = 140.15 SUMP = 135.80 PIPE 1 INV IN = 136.90 PIPE 2 INV OUT = 136.80 | | | |
| CB 4 | RIM = 140.52 SUMP = 136.50 PIPE 1 INV OUT = 137.50 | | | |
| CB 5 | RIM = 139.62 SUMP = 135.60 PIPE 5 INV OUT = 136.60 | | | |
| RIM = 137.58 SUMP = 132.60 PIPE 4 INV IN = 133 | | | | |

PROPOSED WATER SHUT-OFF VALVE

| _ | | | | | | |
|---|--------------------------|--------|-------------------|-------|--|--|
| | * STORM SEWER PIPE TABLE | | | | | |
| | PIPE NAME | LENGTH | SIZE AND MATERIAL | SLOPE | | |
| | PIPE 1 | 37 LF | 15" ø CORR HDPE | 1.62% | | |
| | PIPE 2 | 63 LF | 15" Ø CORR HDPE | 1.20% | | |
| 1 | PIPE 3 | 70 LF | 15" Ø CORR HDPE | 3.07% | | |
| | PIPE 4 | 9 LF | 15" ø CORR HDPE | 1.13% | | |
| | PIPE 5 | 56 LF | 15" ø CORR HDPE | 1.00% | | |
| ١ | | | | | | |

| SANITARY | SEWER STRUCTURE TABLE | | | |
|-----------|---|--|--|--|
| STRUCTURE | STRUCTURE DETAILS | | | |
| SMH 6 | RIM = 140.71 PIPE 6 INV OUT = 135.95 | | | |
| SMH 7 | RIM = 137.52 PIPE 6 INV IN = 133.00 | | | |

| S | ANITARY S | SEWER PIPE TABLE | |
|-----------|-----------|-------------------|-------|
| PIPE NAME | LENGTH | SIZE AND MATERIAL | SLOP |
| PIPE 6 | 179 LF | 8 inch PVC | 1.65% |

| | DRAWN BY: BY | | | CHECKED BY: CHECK | | | | |
|-----|--------------|-----------------------------|-----|-------------------|------------|-------------|----|--|
| | REVISIONS: | | | | REVISIONS: | | | |
| NO. | DATE | DESCRIPTION | BY | NO. | DATE | DESCRIPTION | BY | |
| 1 | 2/26/19 | PER PLANNING BOARD COMMENTS | СМВ | | | | | |
| | | | | | | | | |
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OWNER'S CONSENT:

THE UNDERSIGNED OWNER OF THE PROPERTY HEREON STATES THAT HE IS FAMILIAR WITH THIS MAP, ITS CONTENTS AND ITS LEGENDS AND HEREBY CONSENTS TO ALL SAID TERMS AND CONDITIONS AS STATED HEREON.

PIE DEVELOPMENT DATE





HUDSON LAND DESIGN
PROFESSIONAL ENGINEERING P.C.
174 MAIN ST., BEACON, NEW YORK 12508
13 CHAMBERS ST., NEWBURGH, NEW YORK 12550
PH: 845-440-6926

F: 845-440-6637

GRADING & UTILITY PLAN

53 ELIZA STREET

53 ELIZA STREET
CITY OF BEACON
DUTCHESS COUNTY, NEW YORK
TAX ID: 6054-29-031870

DATE: 8/28/18

JOB #: 2018:032

SCALE: 1"=20'

TITLE: GU-1

SHEET: 4 OF 5

UNAUTHORIZED ALTERATIONS OR ADDITIONS TO THIS DRAWING IS A VIOLATION OF SECTION 7209.2 OF THE NEW YORK EDUCATION LAW